

STAGED CROWN CERTIFICATE

Issued under Environmental Planning and Assessment Act 1979 No. 203 – Part 6, Division 6.3 (6.7)-(6.8) Environmental Planning and Assessment (Development Certification and Fire Safety) Regulation 2021 Part 3 Division 1 & 2

Approval Number: 25000287 / 9

SECTION A THE APPLICATION

Details of the Applicant

Name: The University Of Sydney

Address: Services Building G12, 22 Codrington Street Darlington 2008

Phone: 0466 998 167

Email: janani.suseelar@sydney.edu.au

Application Number: 22000687

Details of the property

Unit / Street Number: Sydney Biomedical Accelerator (SBA) 3

Street Name: Parramatta Road
Suburb & Postcode: Camperdown 2050
Title Particulars (Lot & DP/SP): Lot 1 DP 1171804

Description of Approved Development

Construction and operation of a nine storey (including plant) medical research building and associated infrastructure and public domain works.

Description of the Proposed Development Subject of this Crown Approval

CC2 - Inground Services, Substructure, Service risers

Estimated Cost of Work

\$476,744,235.00

Development Consent (if applicable)

Development Consent No.: SSD-55388456
Date Development Consent issued: 19 Nov 2024
Name of Consent Authority: City Of Sydney

Date Application for the Crown Approval was made

Date CC Application was received: 11 Jun 2025

SECTION B AUTHORITY HAVING JURISDICTION

Name: Curtis Schumann Accreditation No.: BDC3249

Phone: 02 9939 1530

Email: admin@mbc-group.com.au

Address: Suite 3/18 Sydney Road Manly NSW 2095

SECTION C BUILDING CLASSIFICATION & BUILDING CODE OF AUSTRALIA EDITION

Class of the proposed building/s under the Building Code of Australia: 5, 7b, 8 & 9b Building Code of Australia Edition Considered: 2022

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SECTION D ATTACHMENTS

Refer to Appendix A for the attachments for this Crown Approval

FIRE SAFETY SCHEDULE SECTION E

If applicable, refer to attached Fire Safety Schedule for this Crown Approval

SECTION F SCHEDULE OF CONDITIONS

Refer to Appendix B for the Schedule of Conditions for this Certificate

SECTION G DATE OF ISSUE

Date of issue of this Certificate:

10 Nov 2025

SECTION H CERTIFICATION

I certify that work completed in accordance with the documentation accompanying the application for this certificate (with such modifications, if any, verified by me as may be shown on that documentation) will comply with the National Construction Code - Building Code of Australia Volume 1 as applicable to the Classes of buildings concerned.

The development is to be carried out in compliance with the following plans and documentation listed below and endorsed by MBC Group.

Architectural Plans prepared by Denton Corker Marshall - DWG No. XX received Nov 2025

SECTION I SIGNATURE

Signature:

Curtis Schumann Signed by:

Accreditation Number: BDC3249 10 Nov 2025 Date of endorsement: Certificate Number: 25000287 / 9

SECTION J PREVIOUS CROWN CERTIFICATES ISSUED (if applicable)

Mh

Permit Number Permit Issue Date Description

CC1 - Bulk Excavation and CC1 - 25000287/7 27 Jun 2025 Shoring

CC2 - Inground Services, CC1A - 25000287 / 8 04 Aug 2025

Substructure, Service risers



APPENDIX A ATTACHMENTS

25000287 / 9

- Crown Approval Application Form Signed & dated 10.11.25
- Architectural Design Statement prepared by Denton Corker Marshall dated 24 Oct 2025
- SSDA Condition C25 SBA Design Statement Stormwater Management System prepared by WSce Pty Ltd dated 03 Oct 2025
- SSDa Condition B31 Flood Management Design Statement prepared by Mott MacDonald dated 24 Oct 2025
- SSDA Condition B31 (a) & (d) Flood Management Design Statement prepared by WSCE dated 06 Nov 2025
- Civil & Stormwater Design Statement (SSD Conditions B30, C23, C25) prepared by WSce dated 03 Nov 2025
- Civil & Stormwater Design Plans prepared by WSce DWG D19-CI-0-10-0010 (7), D19-CI-1-10-0004 (7), D19-CI-1-10-0011 (8), D19-CI-X-00-0053 (3), D19-CI-X-00-0054 (3), D19-CI-X-40-0011 (6)
- Report on Supplementary Contamination Investigation No. 84711.05.R.001.Rev1 prepared by Douglas Partners dated 03 Sep 2024
- Memorandum No. R.009.Rev0 Site Sub-Soil Class Assessment prepared by Douglas Partners dated 31 Jul 2025
- Hydraulic Design Plans prepared by ACOR Consultants DWG D19-HY-X-00-0001 (3), D19-HY-X-00-0002 (3), D19-HY-0-10-0003 (3), D19-HY-0-10-1001 (3), D19-HY-0-10-1002 (3), D19-HY-1-10-1011 (3), D19-HY-1-10-1012 (3), D19-HY-1-10-1013 (3)
- Hydraulic Design Statement prepared by ACOR Consultants dated 30 Oct 2025
- Structural Design Plans (part, if applicable) prepared by Mott MacDonald DWG XX received Nov 2025
- Structural Design Plans (Post Tensioning) prepared by Interspan DWG D19-PT-1-00-0114 (2), D19-PT-1-00-0124 (2), D19-PT-1-10-0100 (2), D19-PT-1-10-0110 (2) D19-PT-1-10-0120 (2), D19-PT-1-20-0111 (2), D19-PT-1-20-0112 (2), D19-PT-1-20-0113 (2), D19-PT-1-20-0121 (2), D19-PT-1-20-0122 (2) dated 15 Oct 2025
- Structural Design Compliance Certificate prepared by Interspan dated 06 Nov 2025
- Structural Design Compliance Certificate prepared by Mott MacDonald dated 07 Nov 2025
- Waste Management Plan prepared by Richard Crookes Constructions dated 12 May 2025



APPENDIX B CONDITIONS


25000287 / 9


- Compliance with any elements that are not specified as an attachment in this Crown Works Approval do not form part of this approval.
- This Crown Approval does not certify compliance with the conditions of Development Consent No. SSD SSD-55388456 dated 19 Nov 2024. The building works should not commence until the Crown is satisfied that the conditions of the Development Consent that are a pre-requisite to commencement have been appropriately addressed where relevant.
- No approval is given nor implied for the construction of works beyond the scope specifically approved by Crown Approval No 25000287/9 dated 10 Nov 2025.
- All building works associated with the subject development are to be carried out in accordance with the approved documentation listed below in Appendix A - Any departure from the documentation cannot be undertaken without the review and approval by MBC Group
- Where there is any conflict between the Design Documentation and the advice provided by MBC Group, the advice issued takes precedence unless approved by MBC Group.
- In accordance with Section 6.28 of the EP&A Act 1979 Crown new Building Works is to comply with the Building Code of Australia (2022).
- Alteration of a relevant fire safety system subject to certification provided by an accredited practitioner Fire Safety.
- MBC Group is to be contacted to undertake progress inspections throughout the development to ensure that the works are being carried out in accordance with the approved documentation.


Advisory Notes


• Where the cost of works exceeds \$250,000, the Head Contractor is to ensure that they have addressed their obligations under the Building and Construction Industry Long Service Payment Act 1986.

The Crown & principal contractor is to obtain any relevant approvals required under Section 68 of the Local Government Act 1993 from City Of Sydney (including but not limited to water, sewer, stormwater, on-site sewer management, trade waste) and the relevant service providers (including, but not limited to, water, gas, telecommunications & electricity).

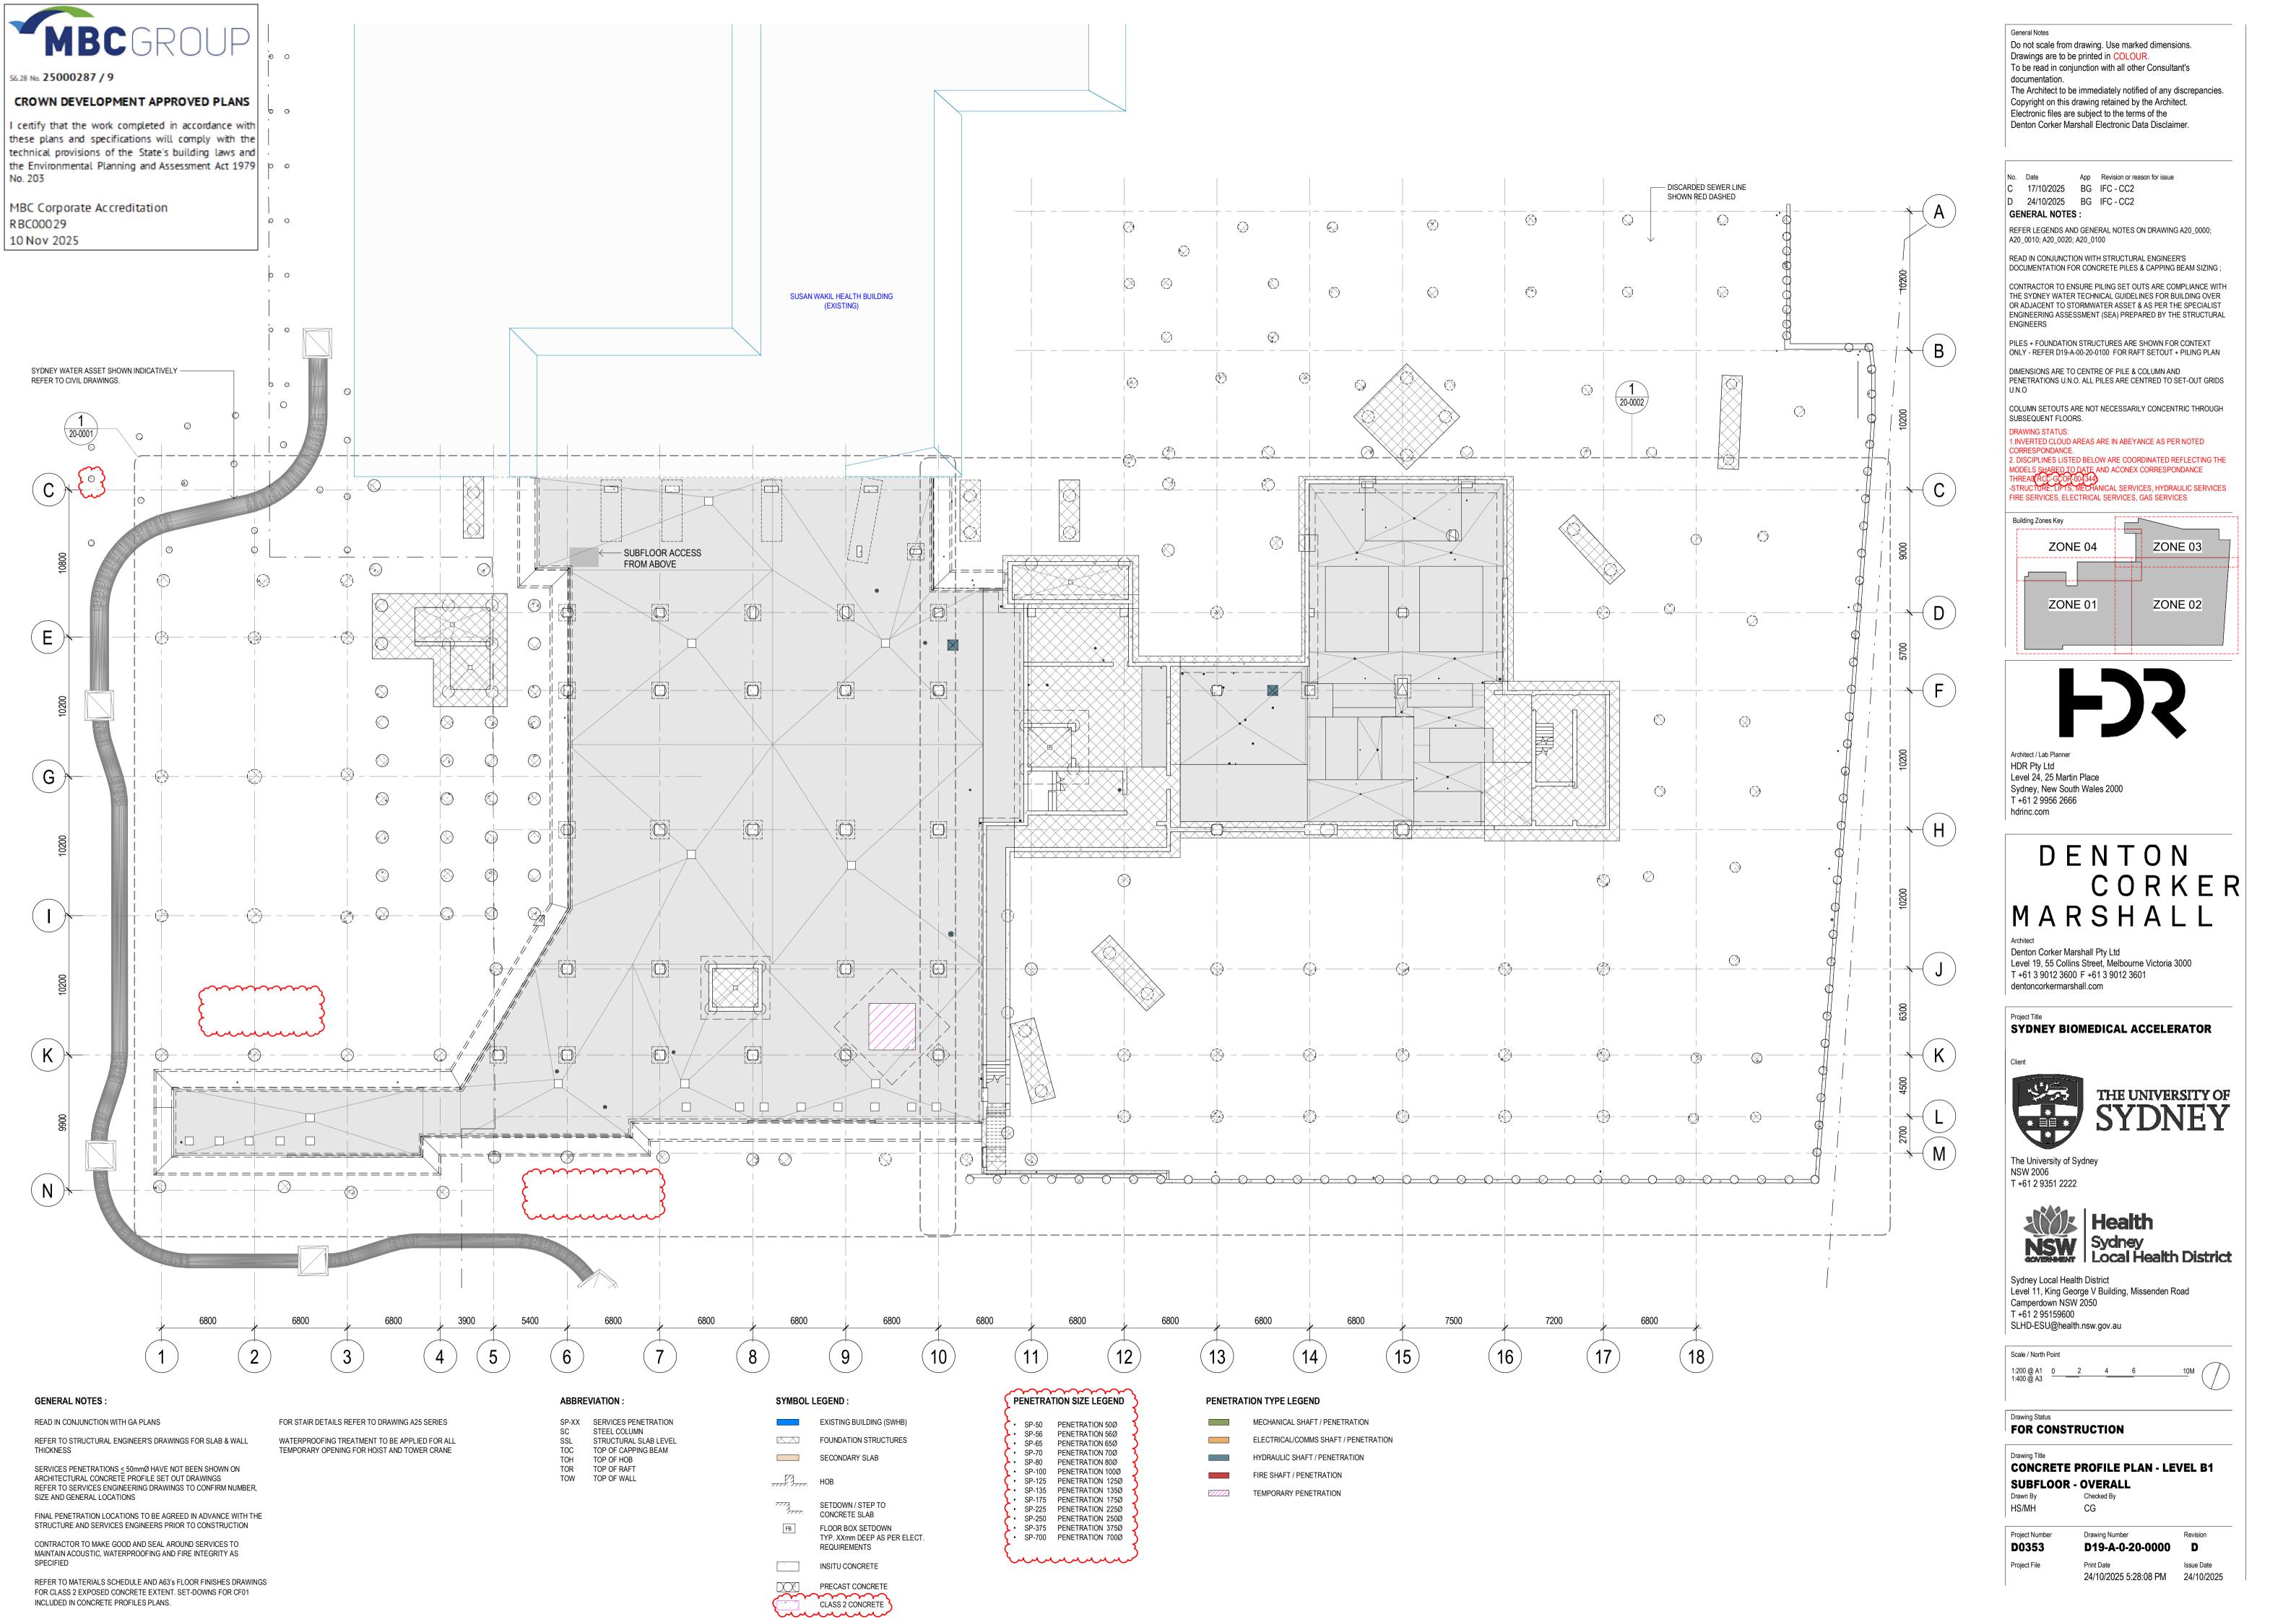


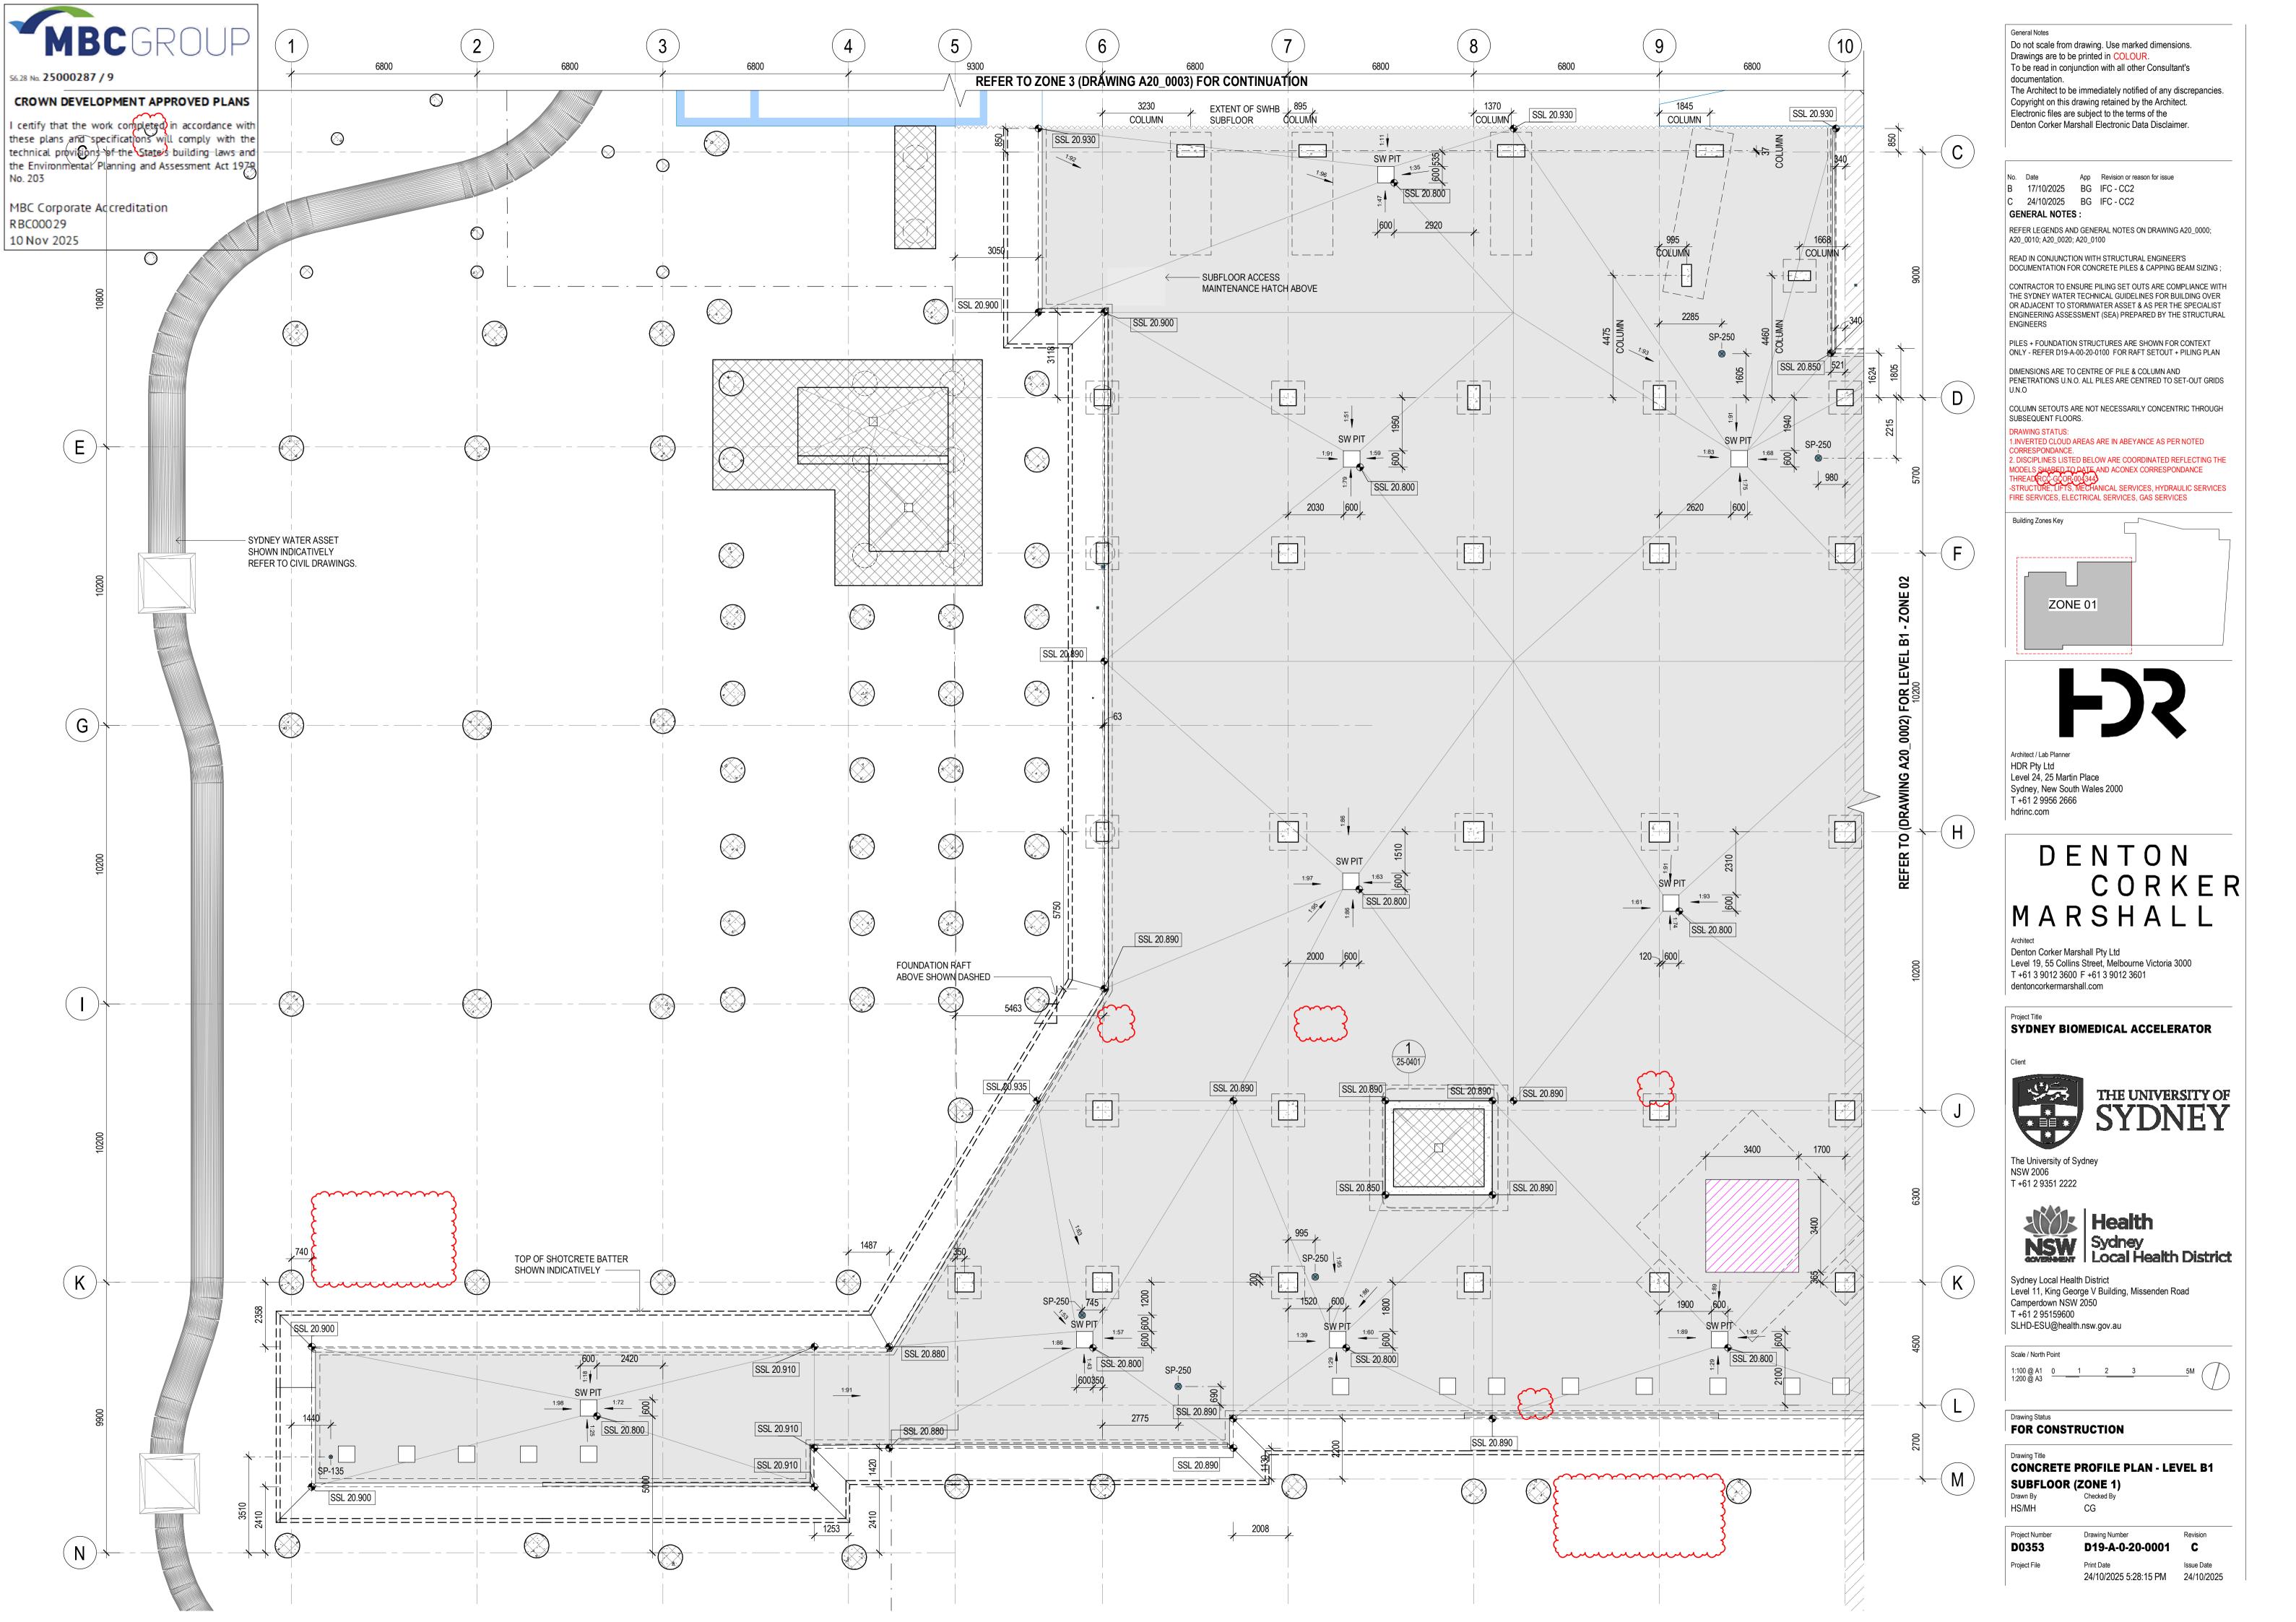


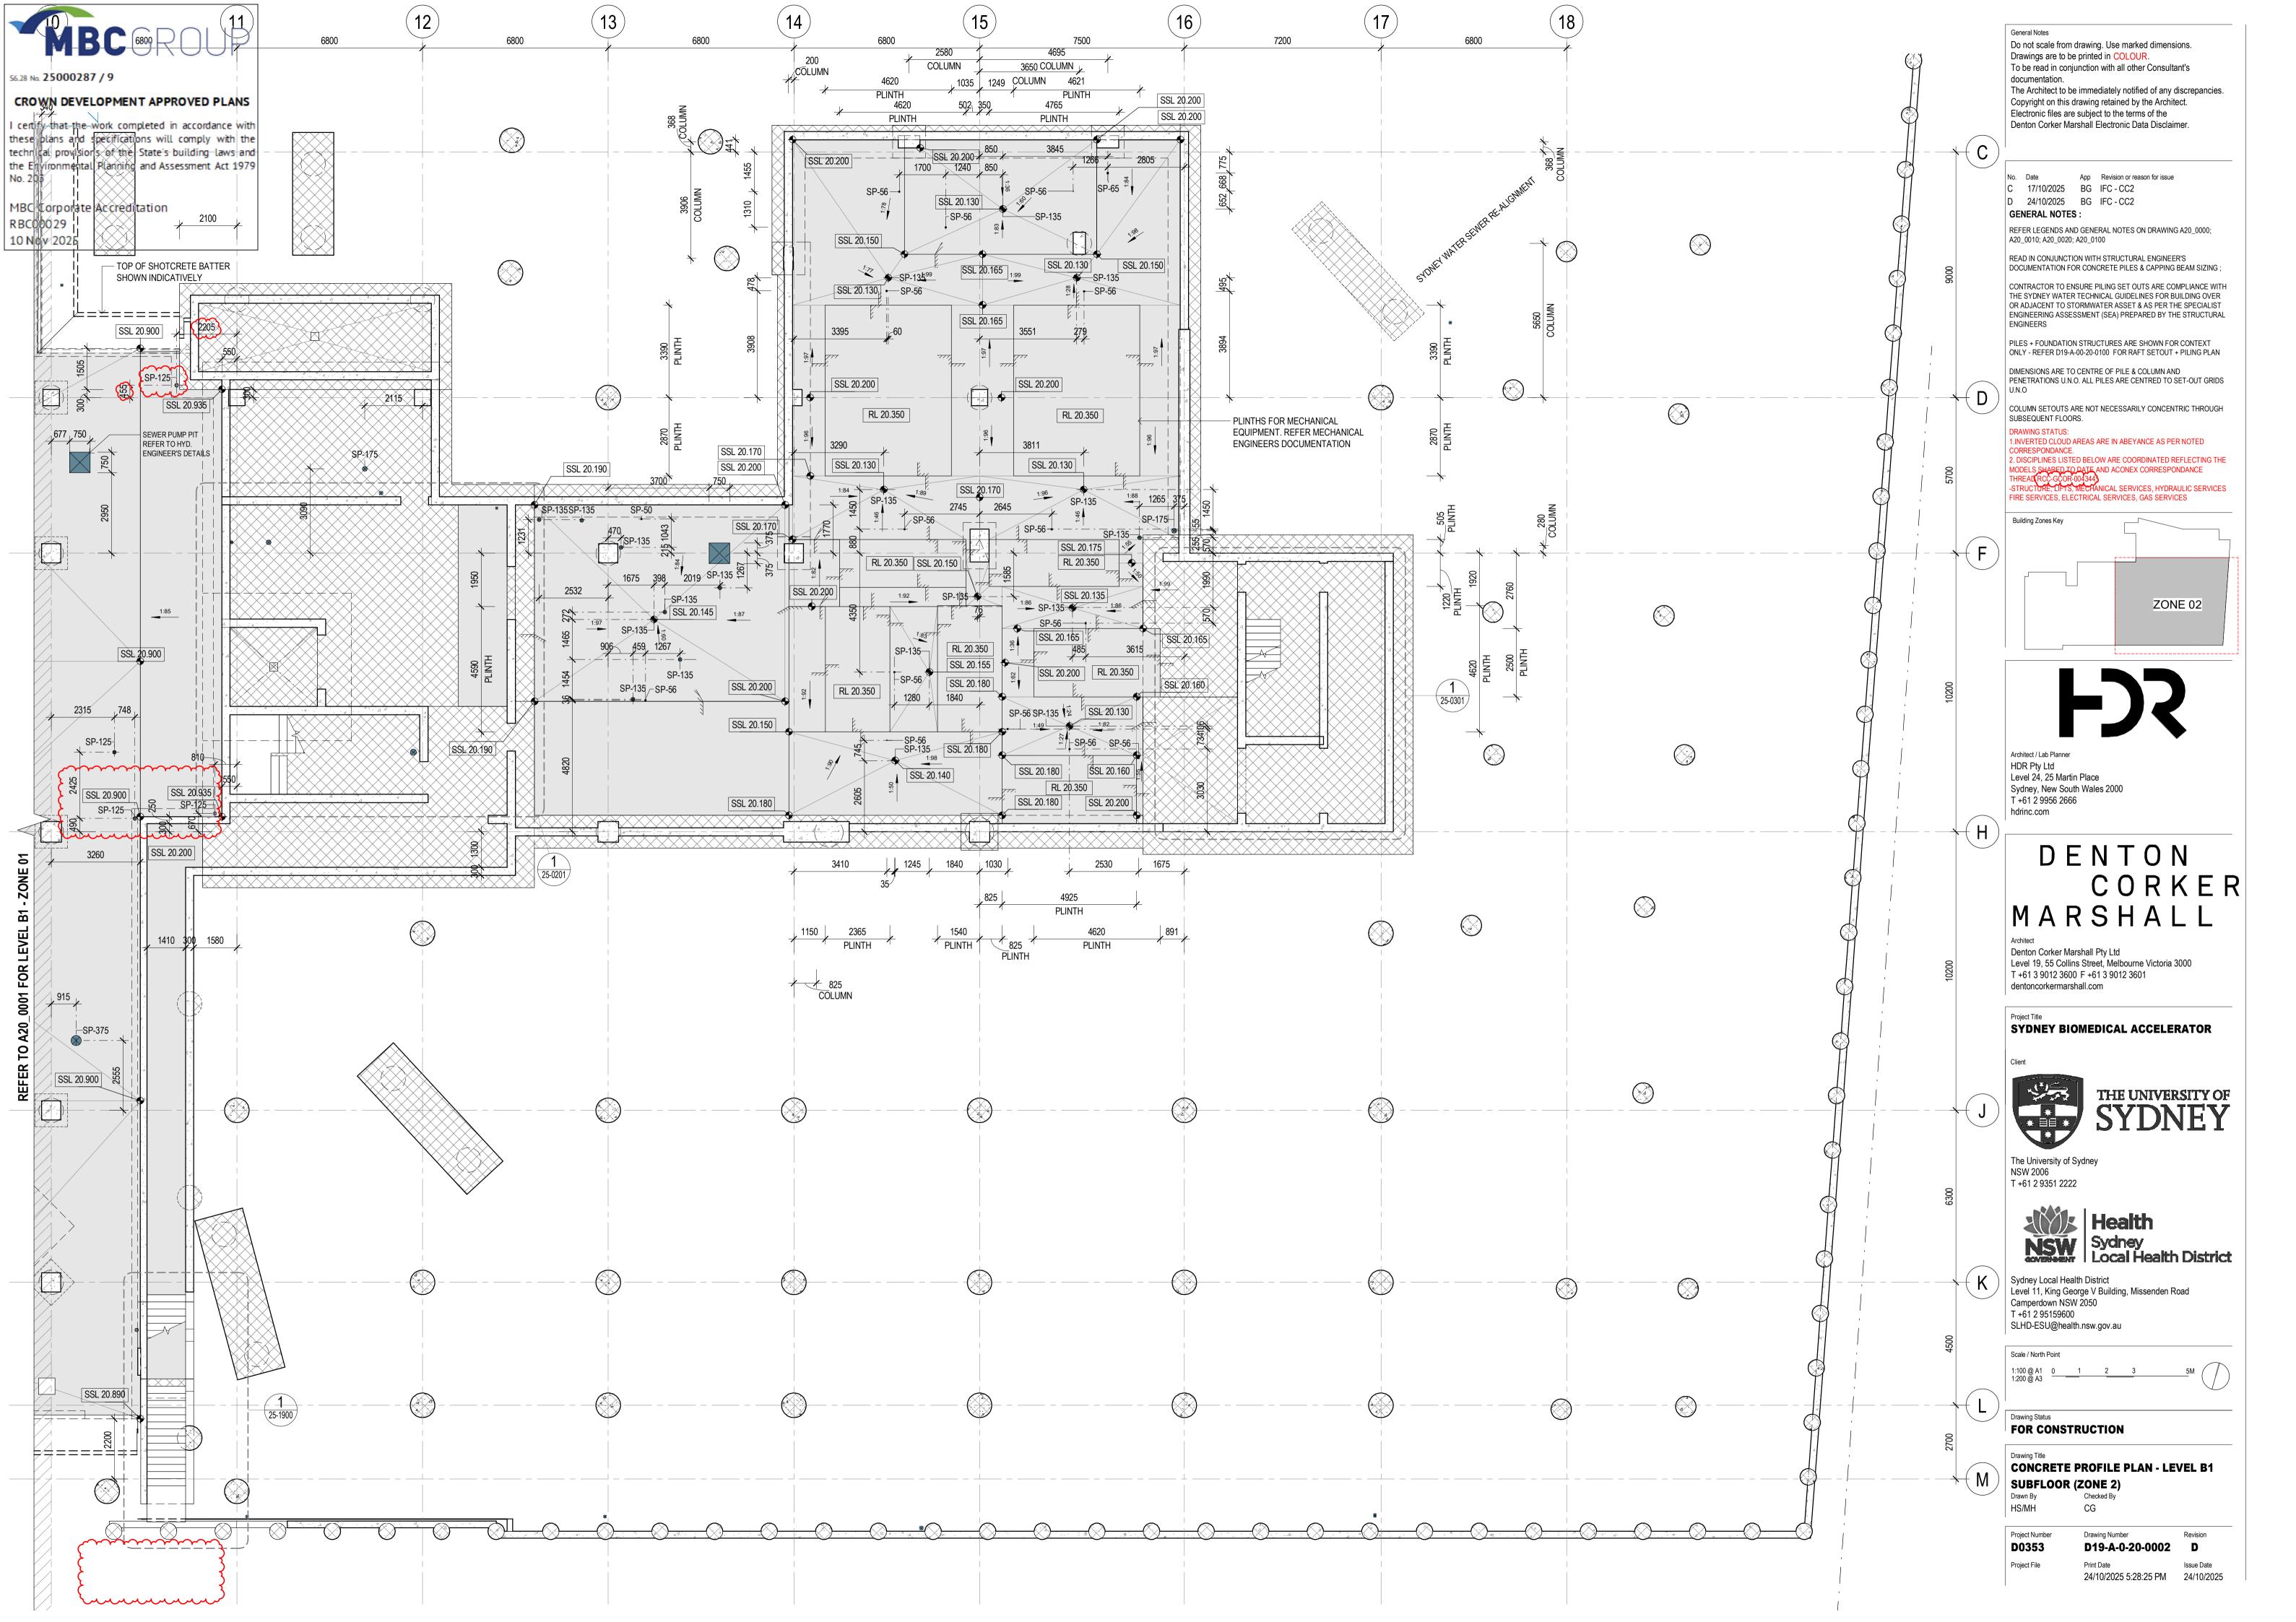

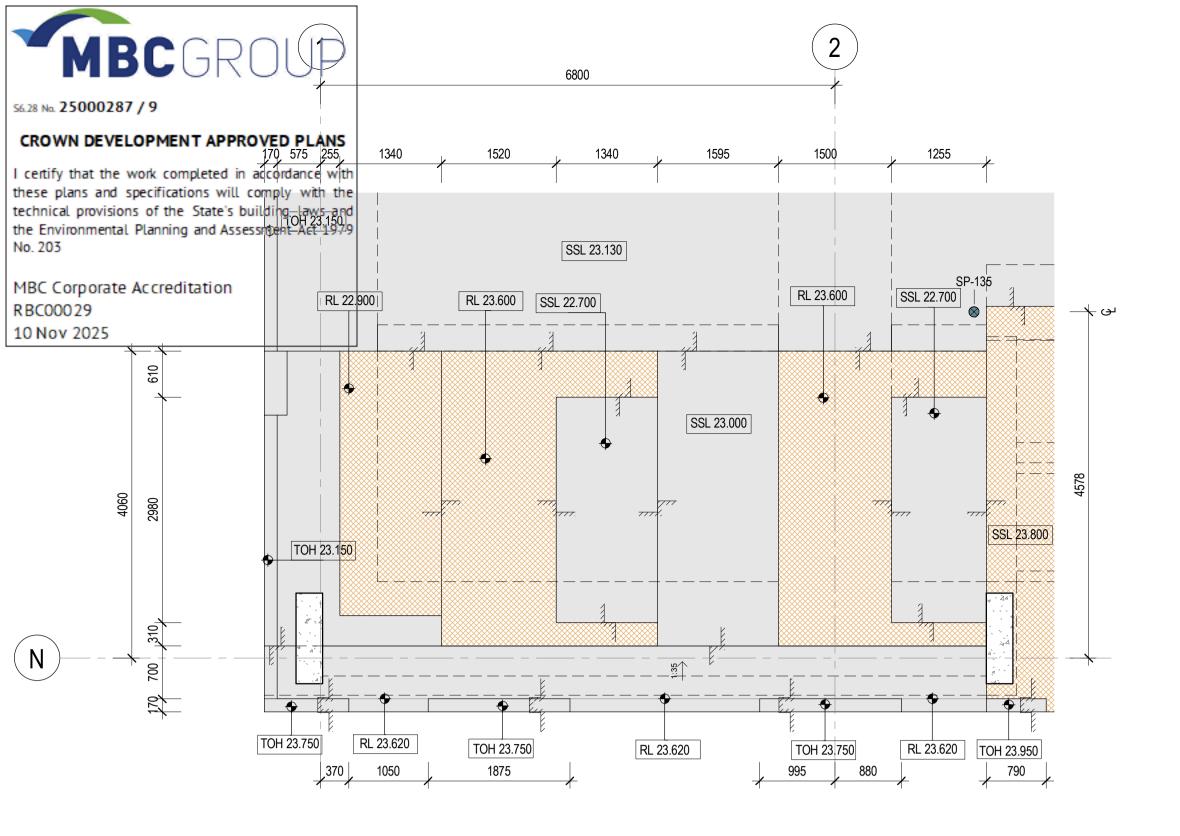


2 PLAN - SECONDARY SLAB (BUILDING B)
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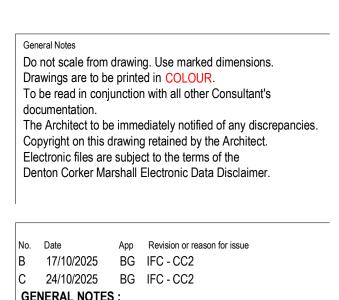


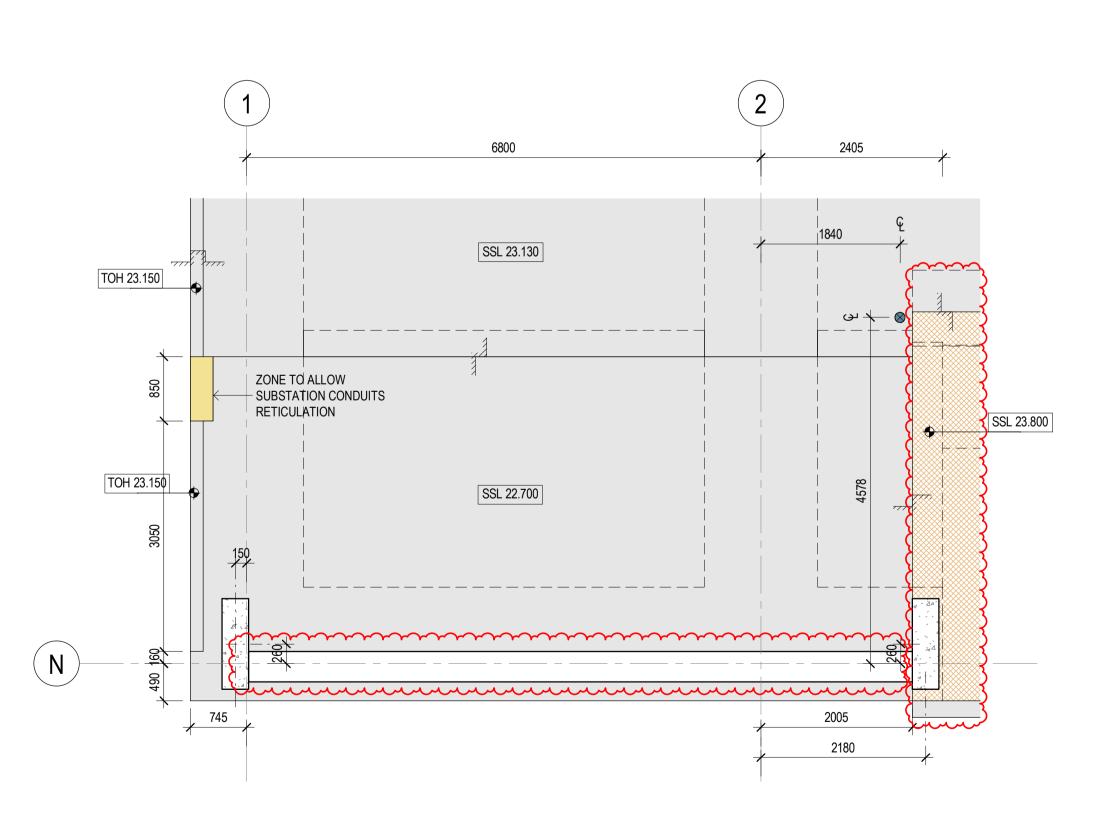

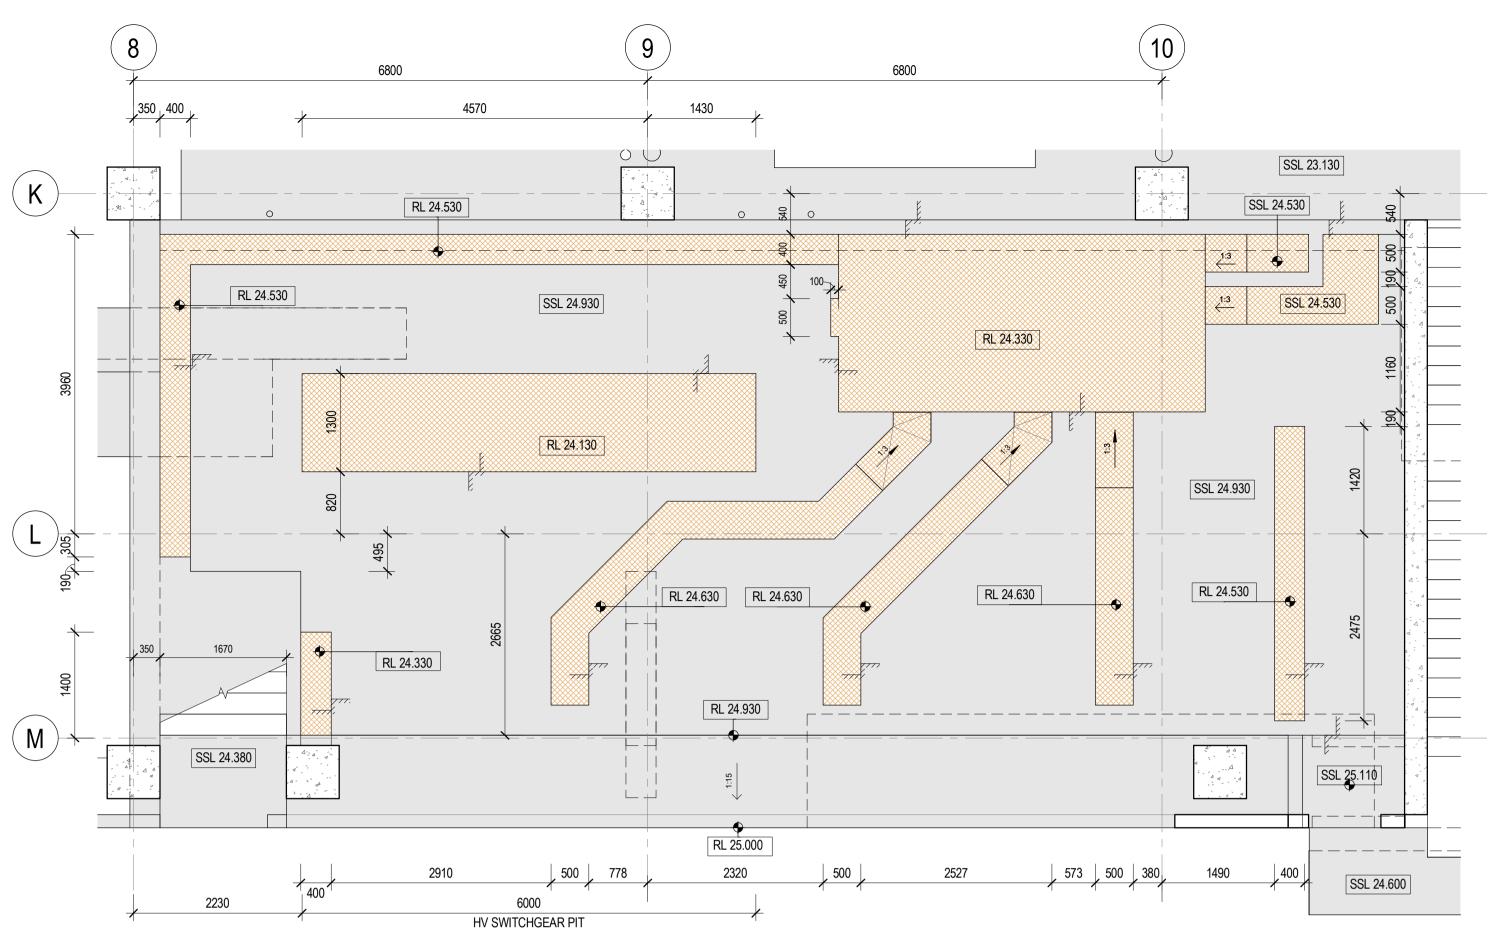4 PLAN - SECONDARY SLAB (IWBB)
20-0011 SCALE 1:50

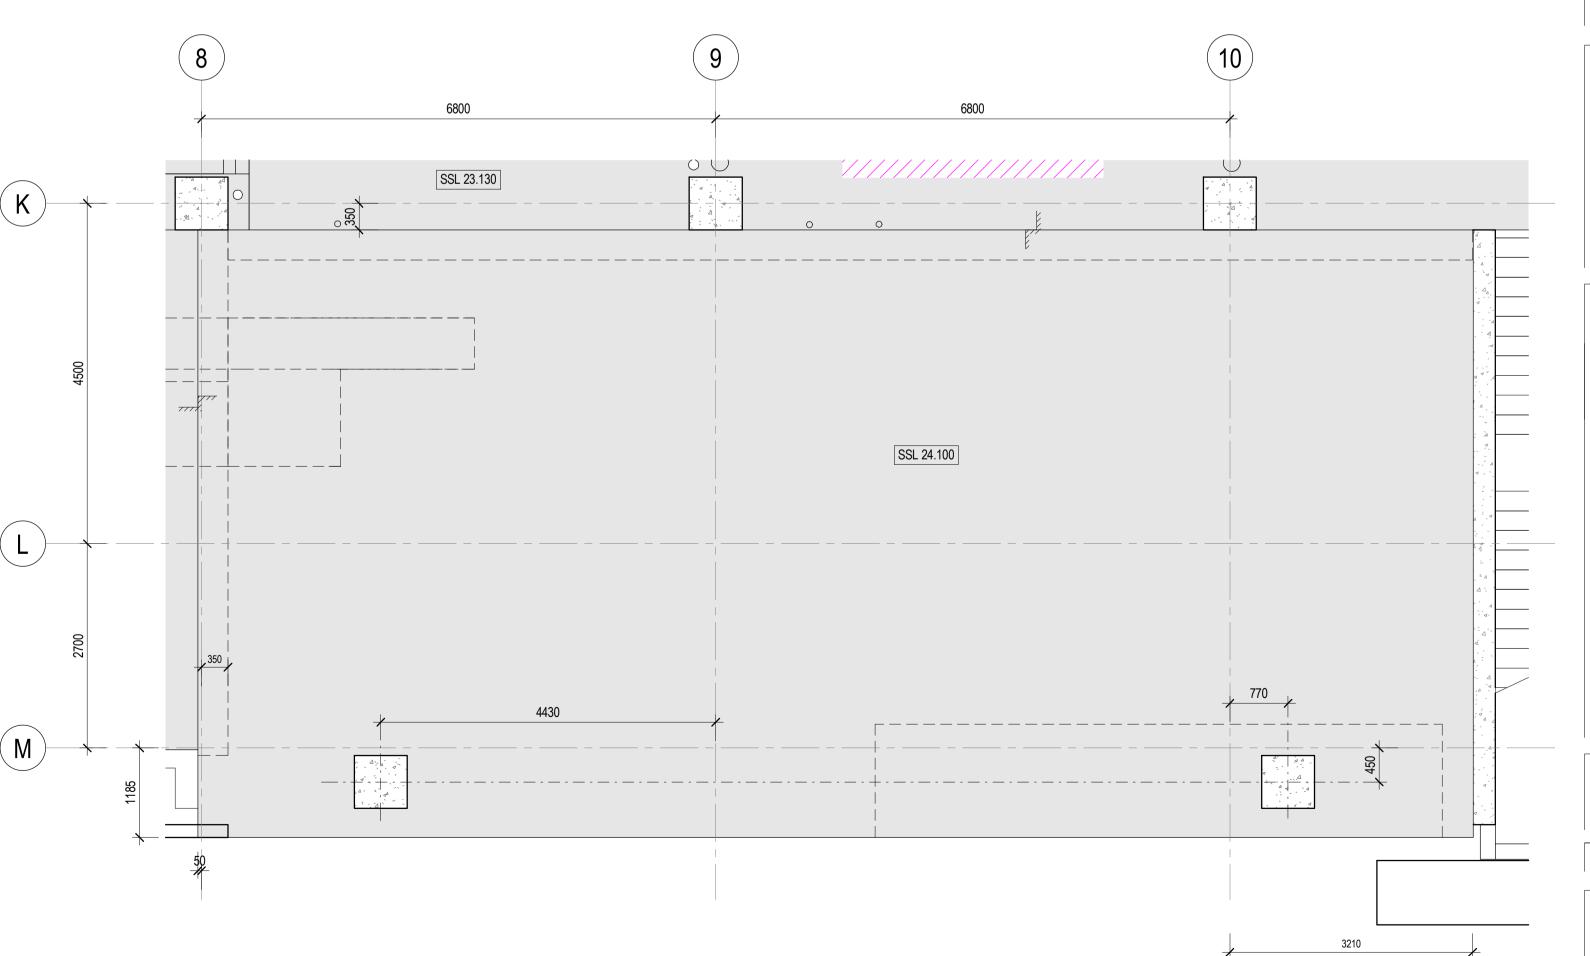

TO BE READ IN CONJUNCTION WITH AUSGRID CERTIFIED DESIGN AN-25206



GENERAL NOTES:

REFER LEGENDS AND GENERAL NOTES ON DRAWING A20_0000;
A20_0010; A20_0020; A20_0100

READ IN CONJUNCTION WITH STRUCTURAL ENGINEER'S DOCUMENTATION FOR CONCRETE PILES & CAPPING BEAM SIZING;

CONTRACTOR TO ENSURE PILING SET OUTS ARE COMPLIANCE WITH THE SYDNEY WATER TECHNICAL GUIDELINES FOR BUILDING OVER OR ADJACENT TO STORMWATER ASSET & AS PER THE SPECIALIST ENGINEERING ASSESSMENT (SEA) PREPARED BY THE STRUCTURAL ENGINEERS

PILES + FOUNDATION STRUCTURES ARE SHOWN FOR CONTEXT ONLY - REFER D19-A-00-20-0100 FOR RAFT SETOUT + PILING PLAN

DIMENSIONS ARE TO CENTRE OF PILE & COLUMN AND PENETRATIONS U.N.O. ALL PILES ARE CENTRED TO SET-OUT GRIDS

COLUMN SETOUTS ARE NOT NECESSARILY CONCENTRIC THROUGH SUBSEQUENT FLOORS.

DRAWING STATUS:

CORRESPONDANCE.

2. DISCIPLINES LISTED BELOW ARE COORDINATED REFLECTING THE MODELS SHARED TO DATE AND ACONEX CORRESPONDANCE THREAD(RCC-GCOR-004344)
-STRUCTURE, LIFTS, MECHANICAL SERVICES, HYDRAULIC SERVICES

FIRE SERVICES, ELECTRICAL SERVICES, GAS SERVICES

1.INVERTED CLOUD AREAS ARE IN ABEYANCE AS PER NOTED

ZONE 04 ZONE 03

ZONE 01 ZONE 02



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Client

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Sydney Local Health District
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Camperdown NSW 2050

Camperdown NSW 2050 T +61 2 95159600 SLHD-ESU@health.nsw.gov.au

Scale / North Point

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1:100 @ A3

Drawing Status
FOR CONSTRUCTION

Drawing Title

CONCRETE PROFILE PLAN - LEVEL 01

SUBSTATIONS


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 Project Number
 Drawing Number
 Revision

 D0353
 D19-A-0-20-1001
 C

 Project File
 Print Date
 Issue Date

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App Revision or reason for issue

1. REFER TO DRAWING A20_0100 FOR LEGENDS AND 2. TO BE READ IN CONJUNCTION WITH STRUCTURAL

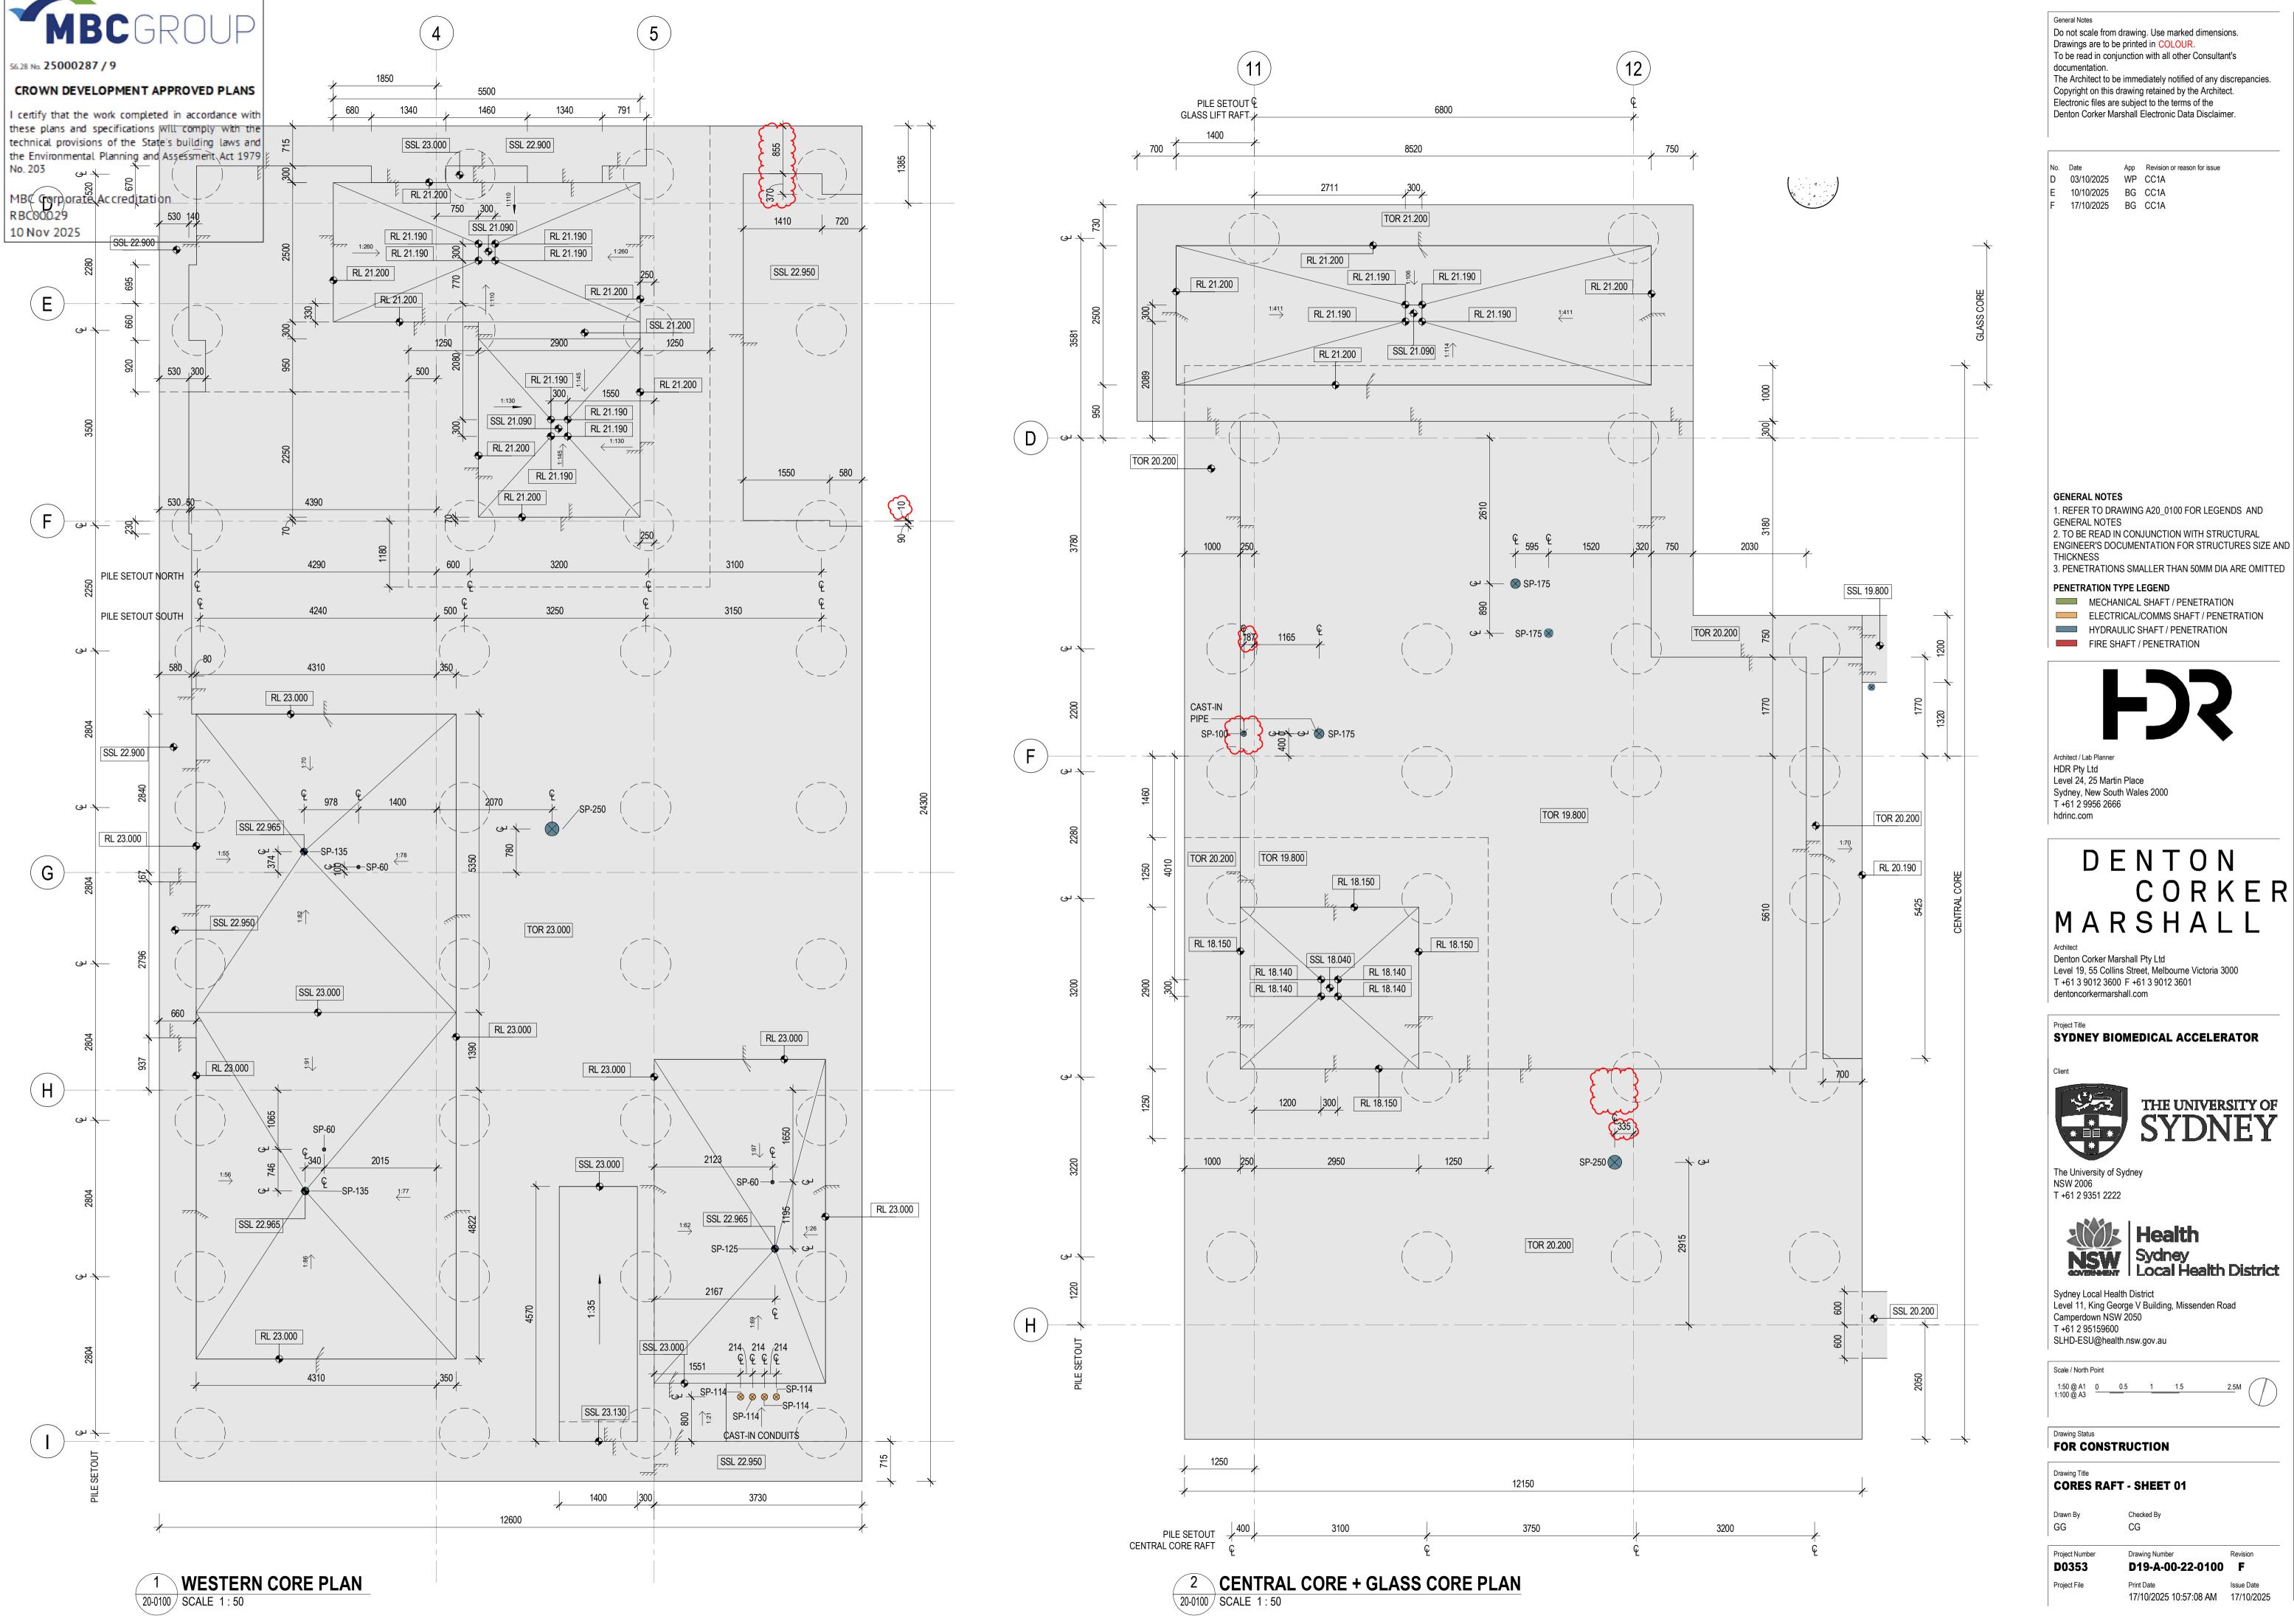3. PENETRATIONS SMALLER THAN 50MM DIA ARE OMITTED

MECHANICAL SHAFT / PENETRATION ELECTRICAL/COMMS SHAFT / PENETRATION



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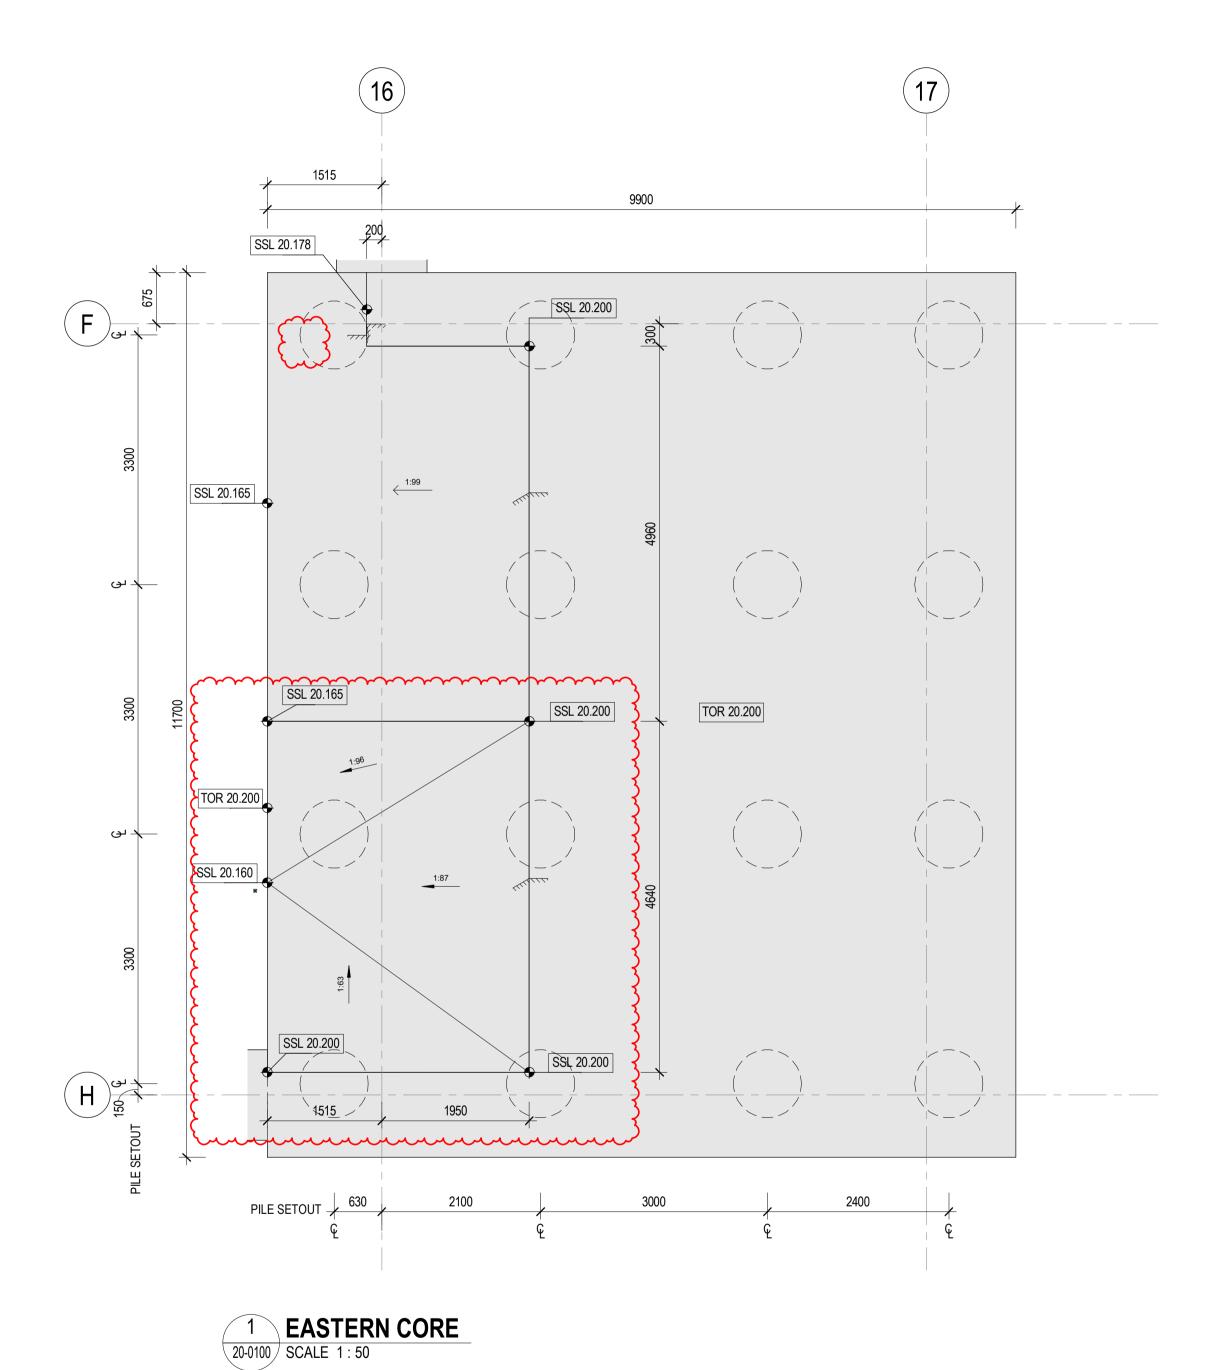



CROWN DEVELOPMENT APPROVED PLANS

I certify that the work completed in accordance with these plans and specifications will comply with the technical provisions of the State's building laws and the Environmental Planning and Assessment Act 1979 No. 203

MBC Corporate Accreditation

RBC00029 10 Nov 2025



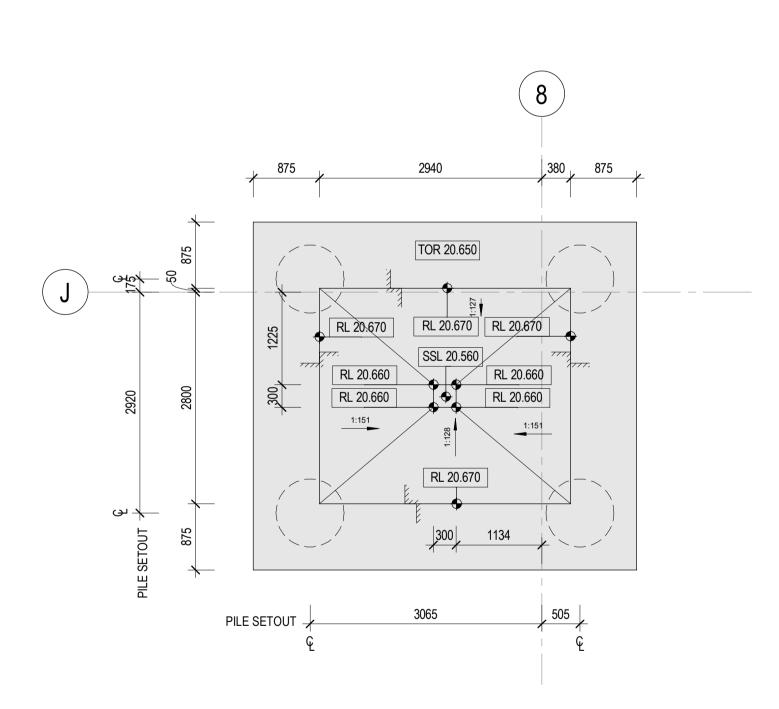

2 SOUTHERN CORE 20-0100 SCALE 1:50

General Notes

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No. Date App Revision or reason for issue D 03/10/2025 WP CC1A E 10/10/2025 BG CC1A F 17/10/2025 BG CC1A

GENERAL NOTES

1. REFER TO DRAWING A20_0100 FOR LEGENDS AND GENERAL NOTES 2. TO BE READ IN CONJUNCTION WITH STRUCTURAL ENGINEER'S DOCUMENTATION FOR STRUCTURES SIZE AND

3. PENETRATIONS SMALLER THAN 50MM DIA ARE OMITTED

PENETRATION TYPE LEGEND

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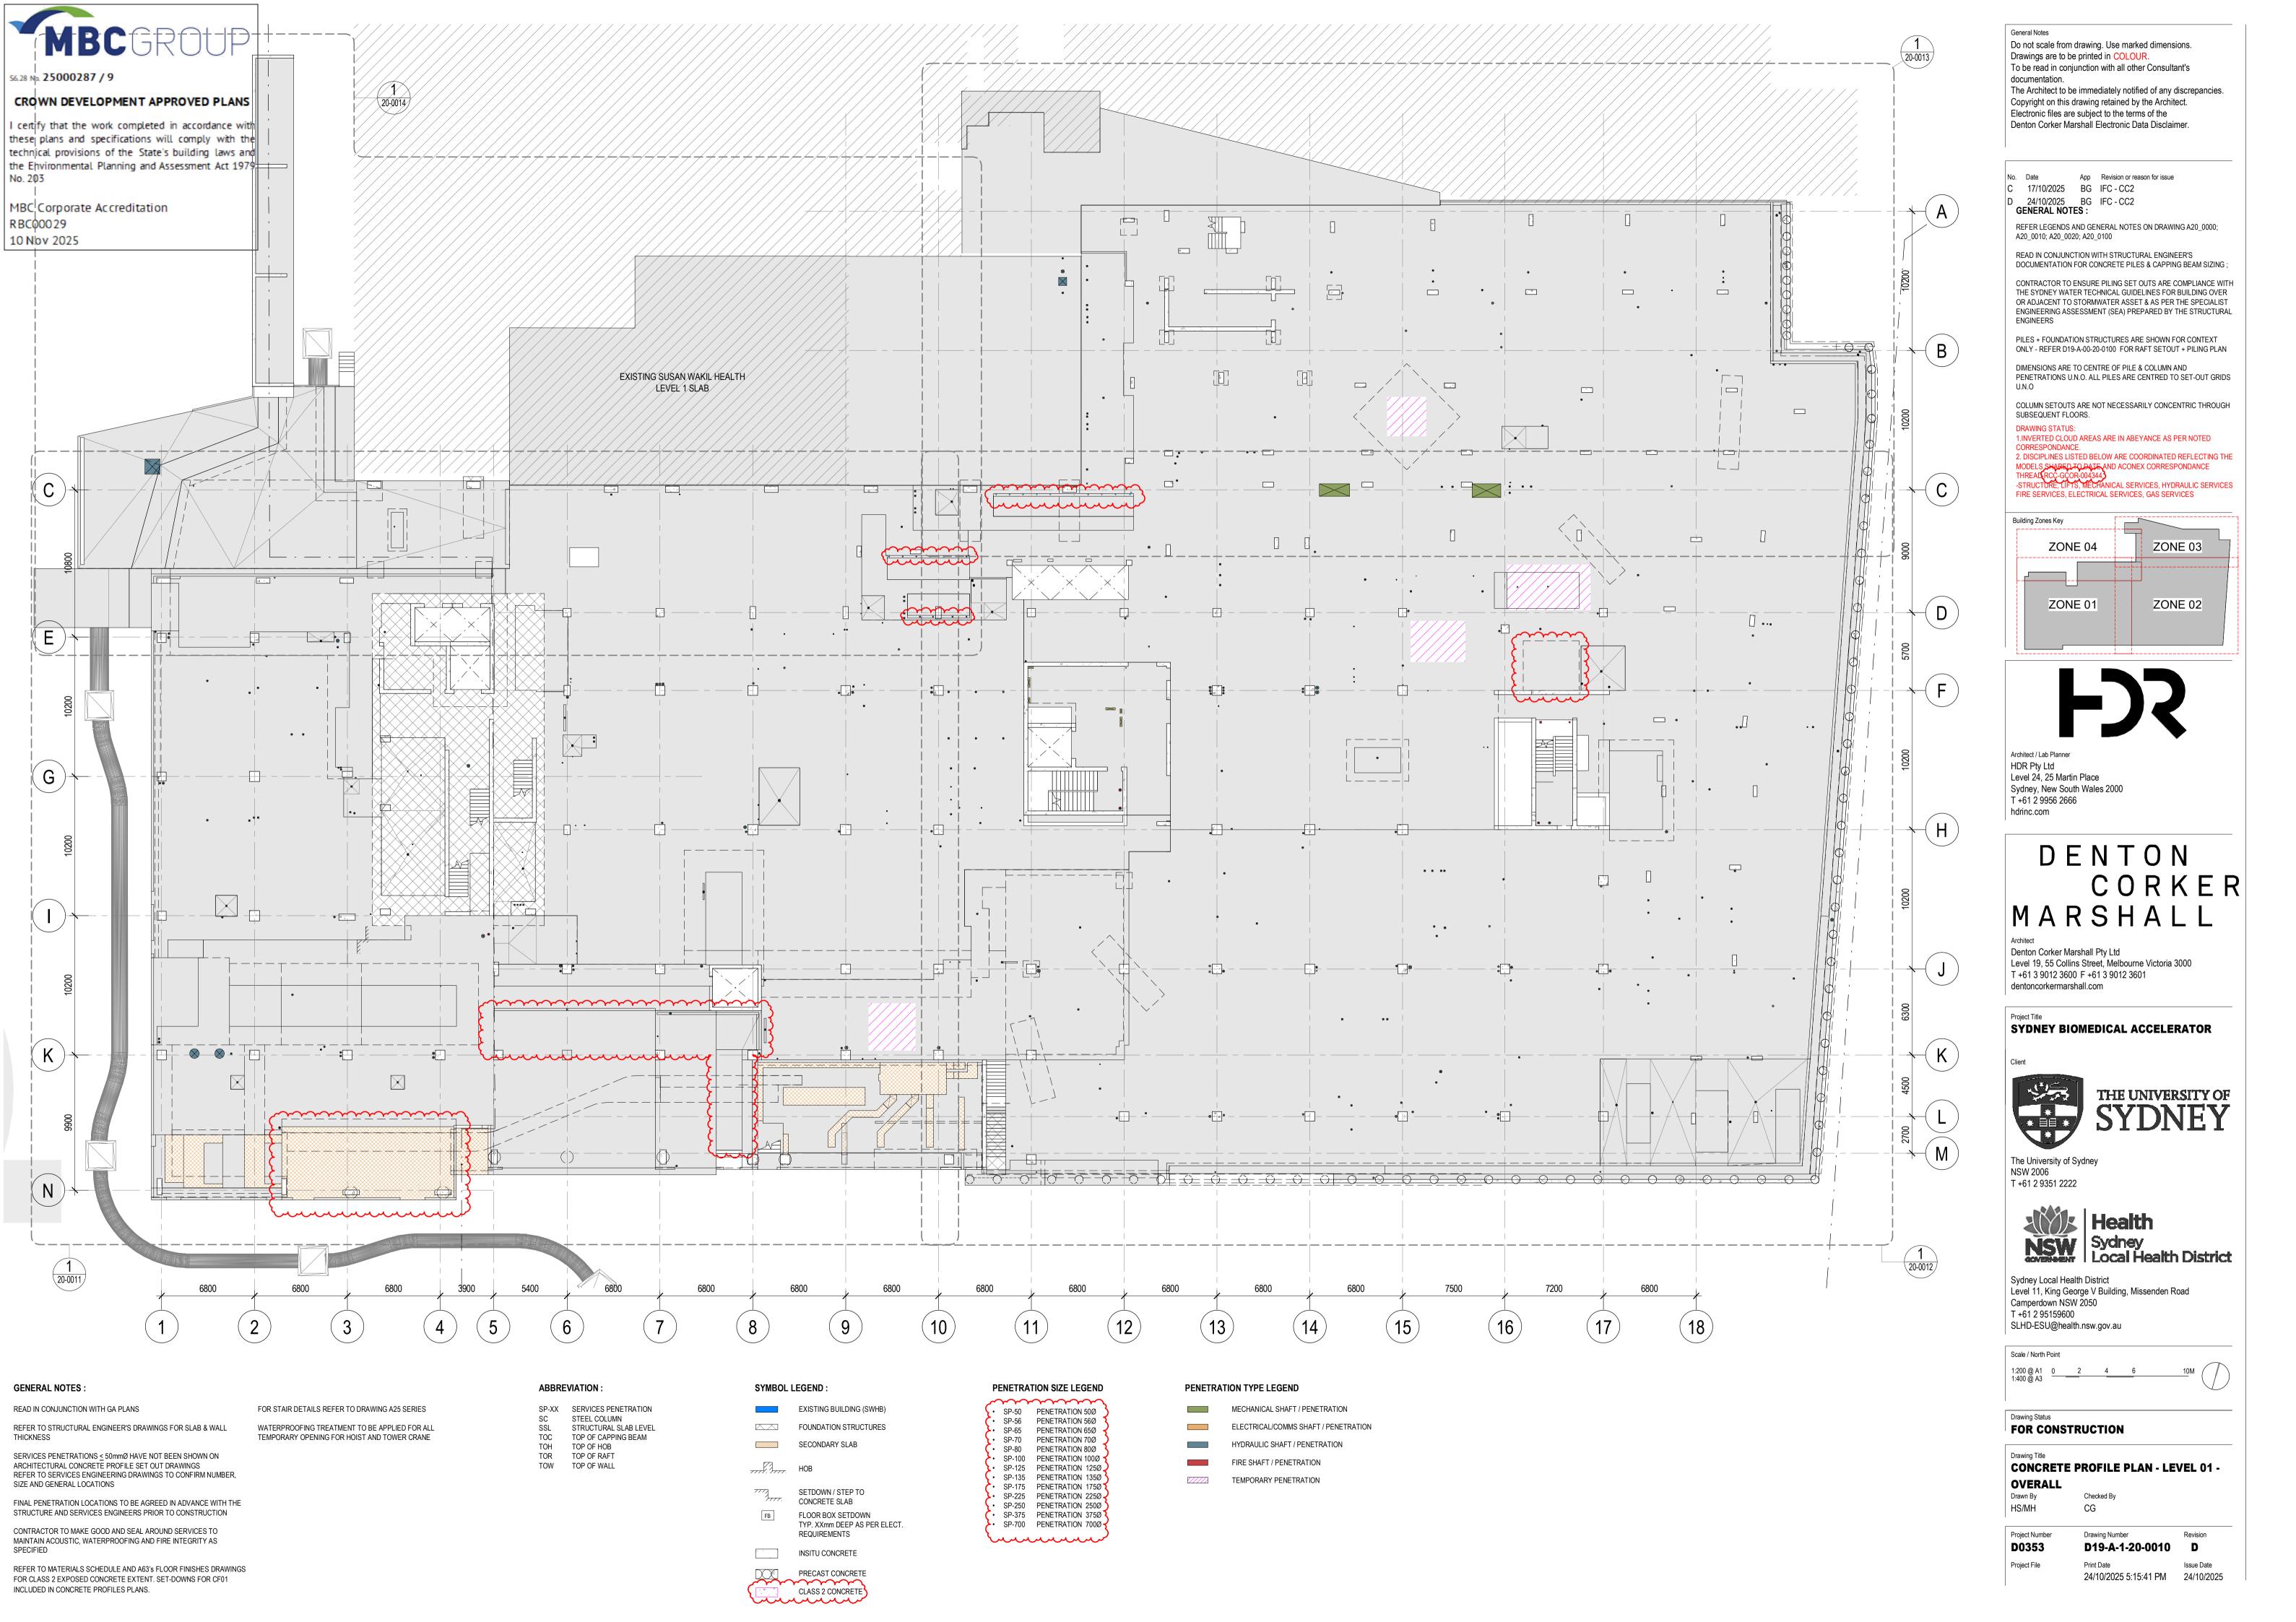
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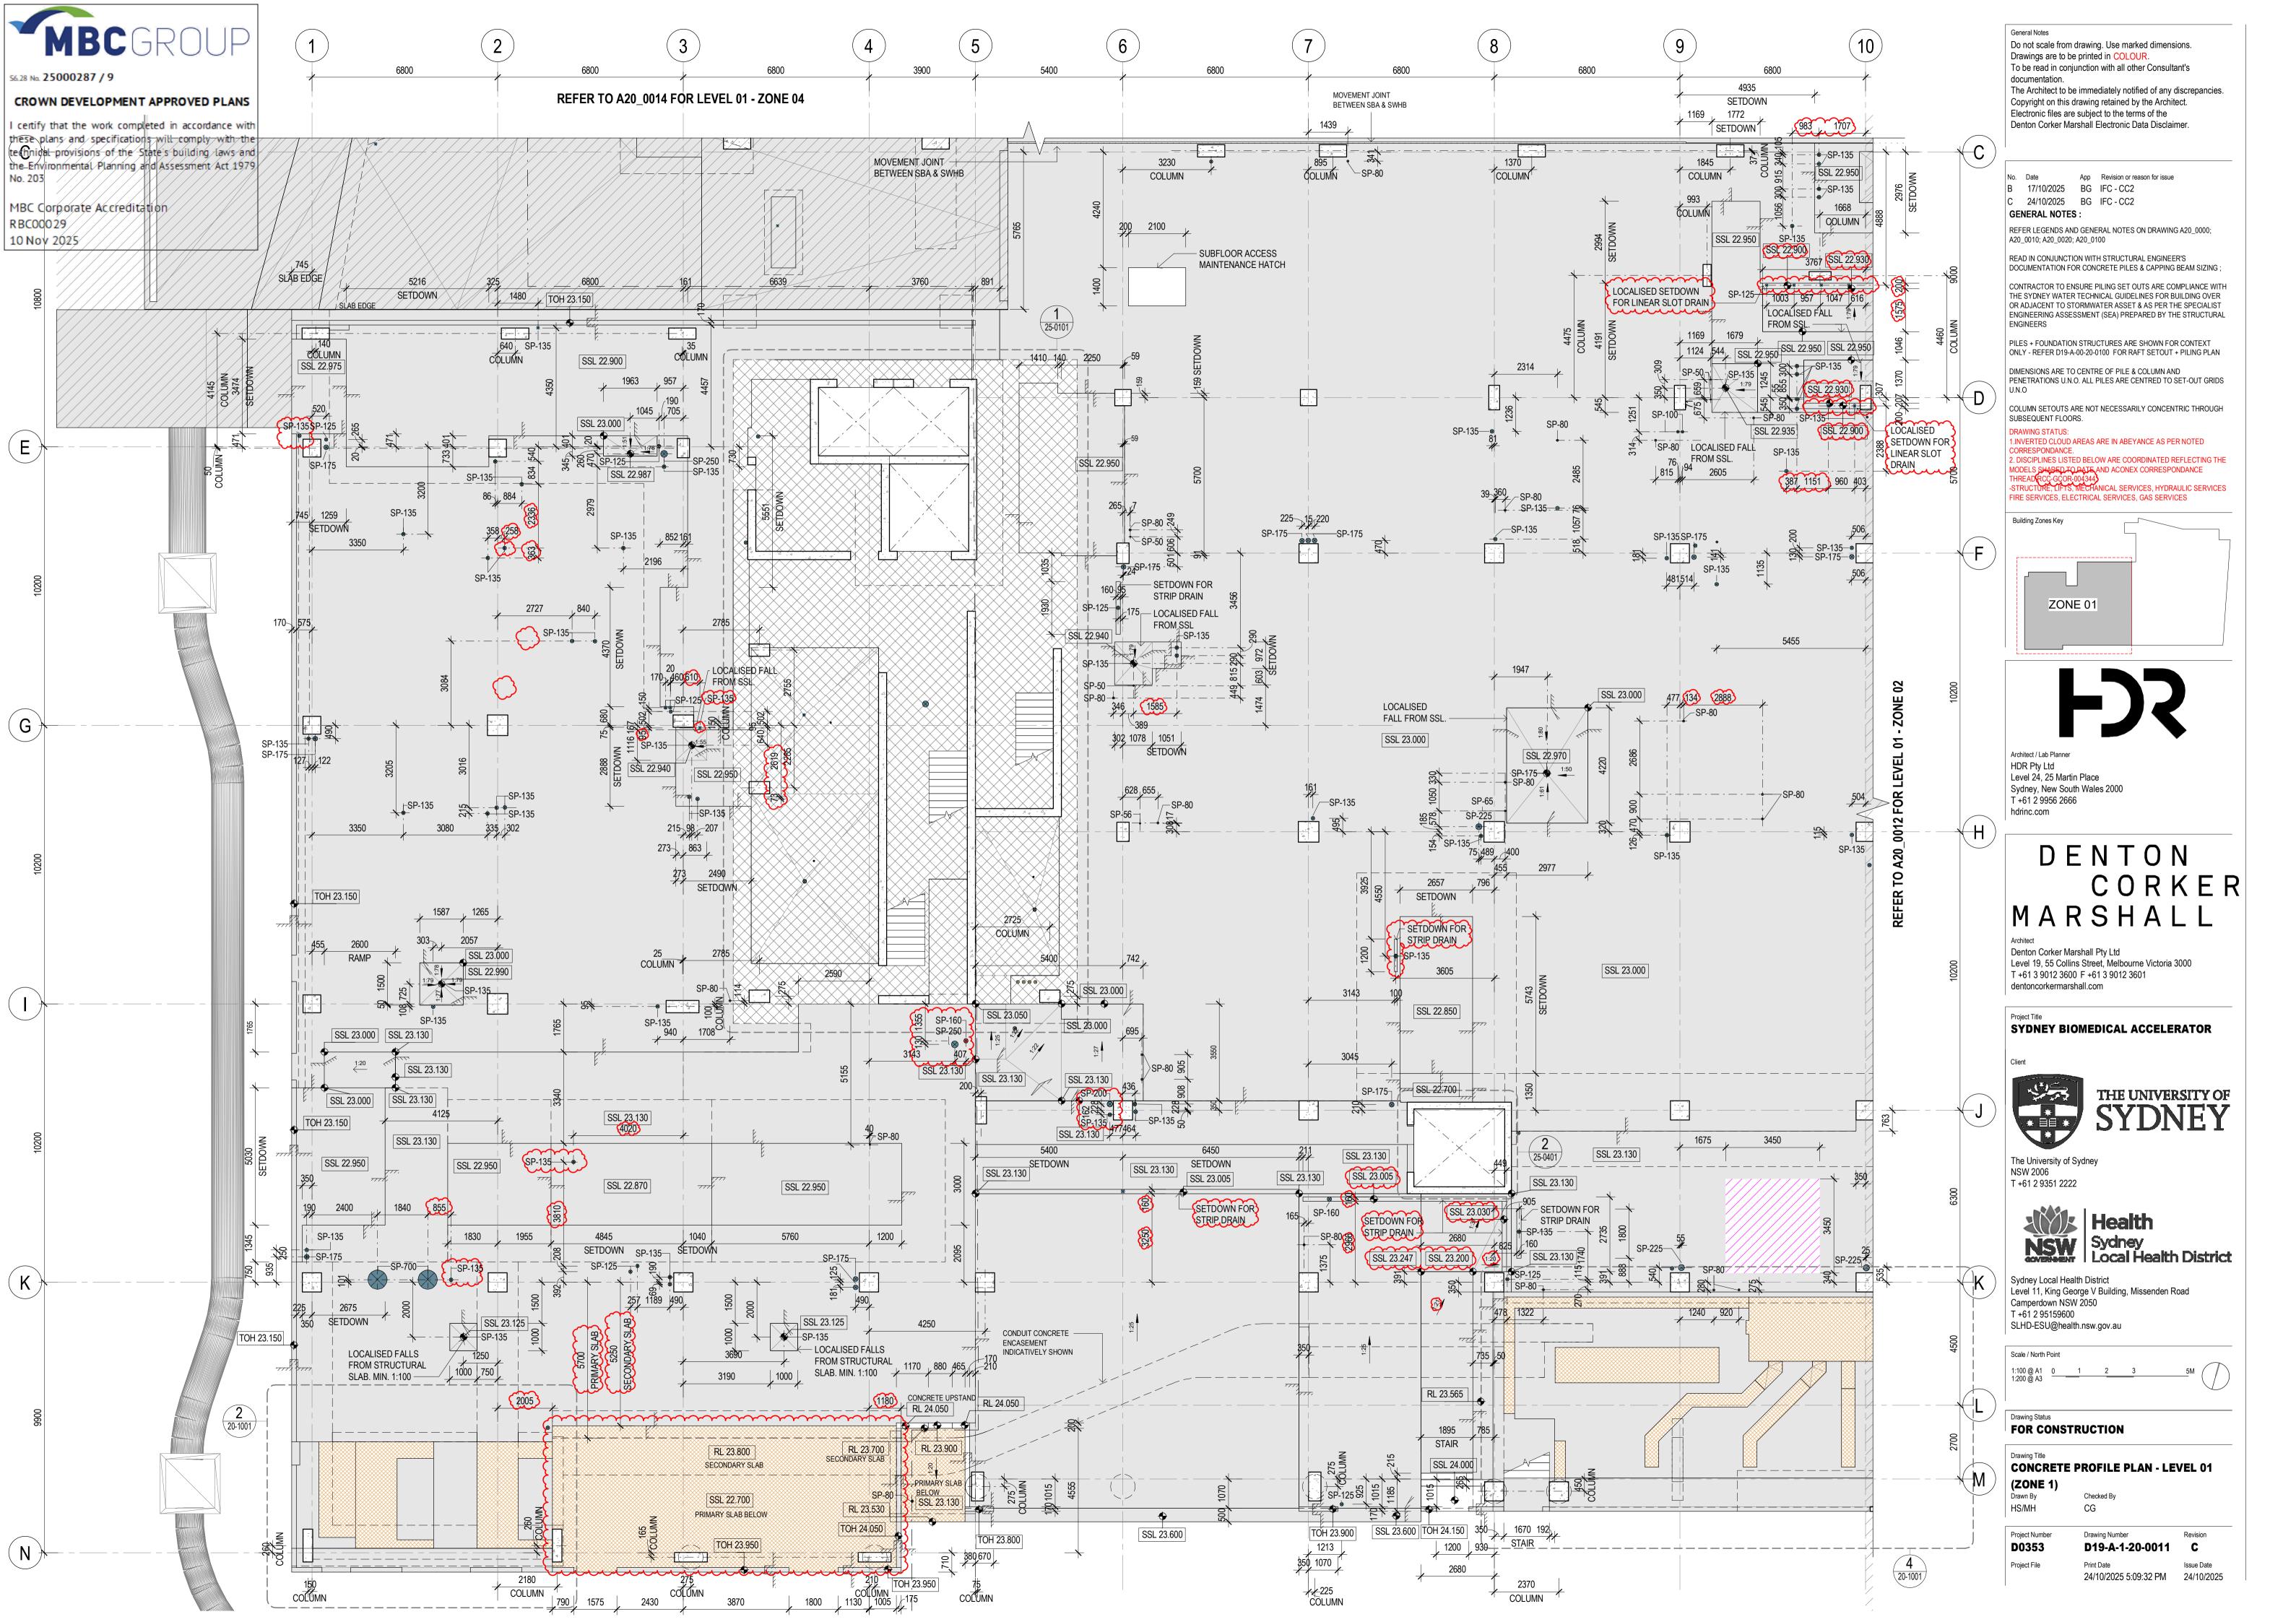
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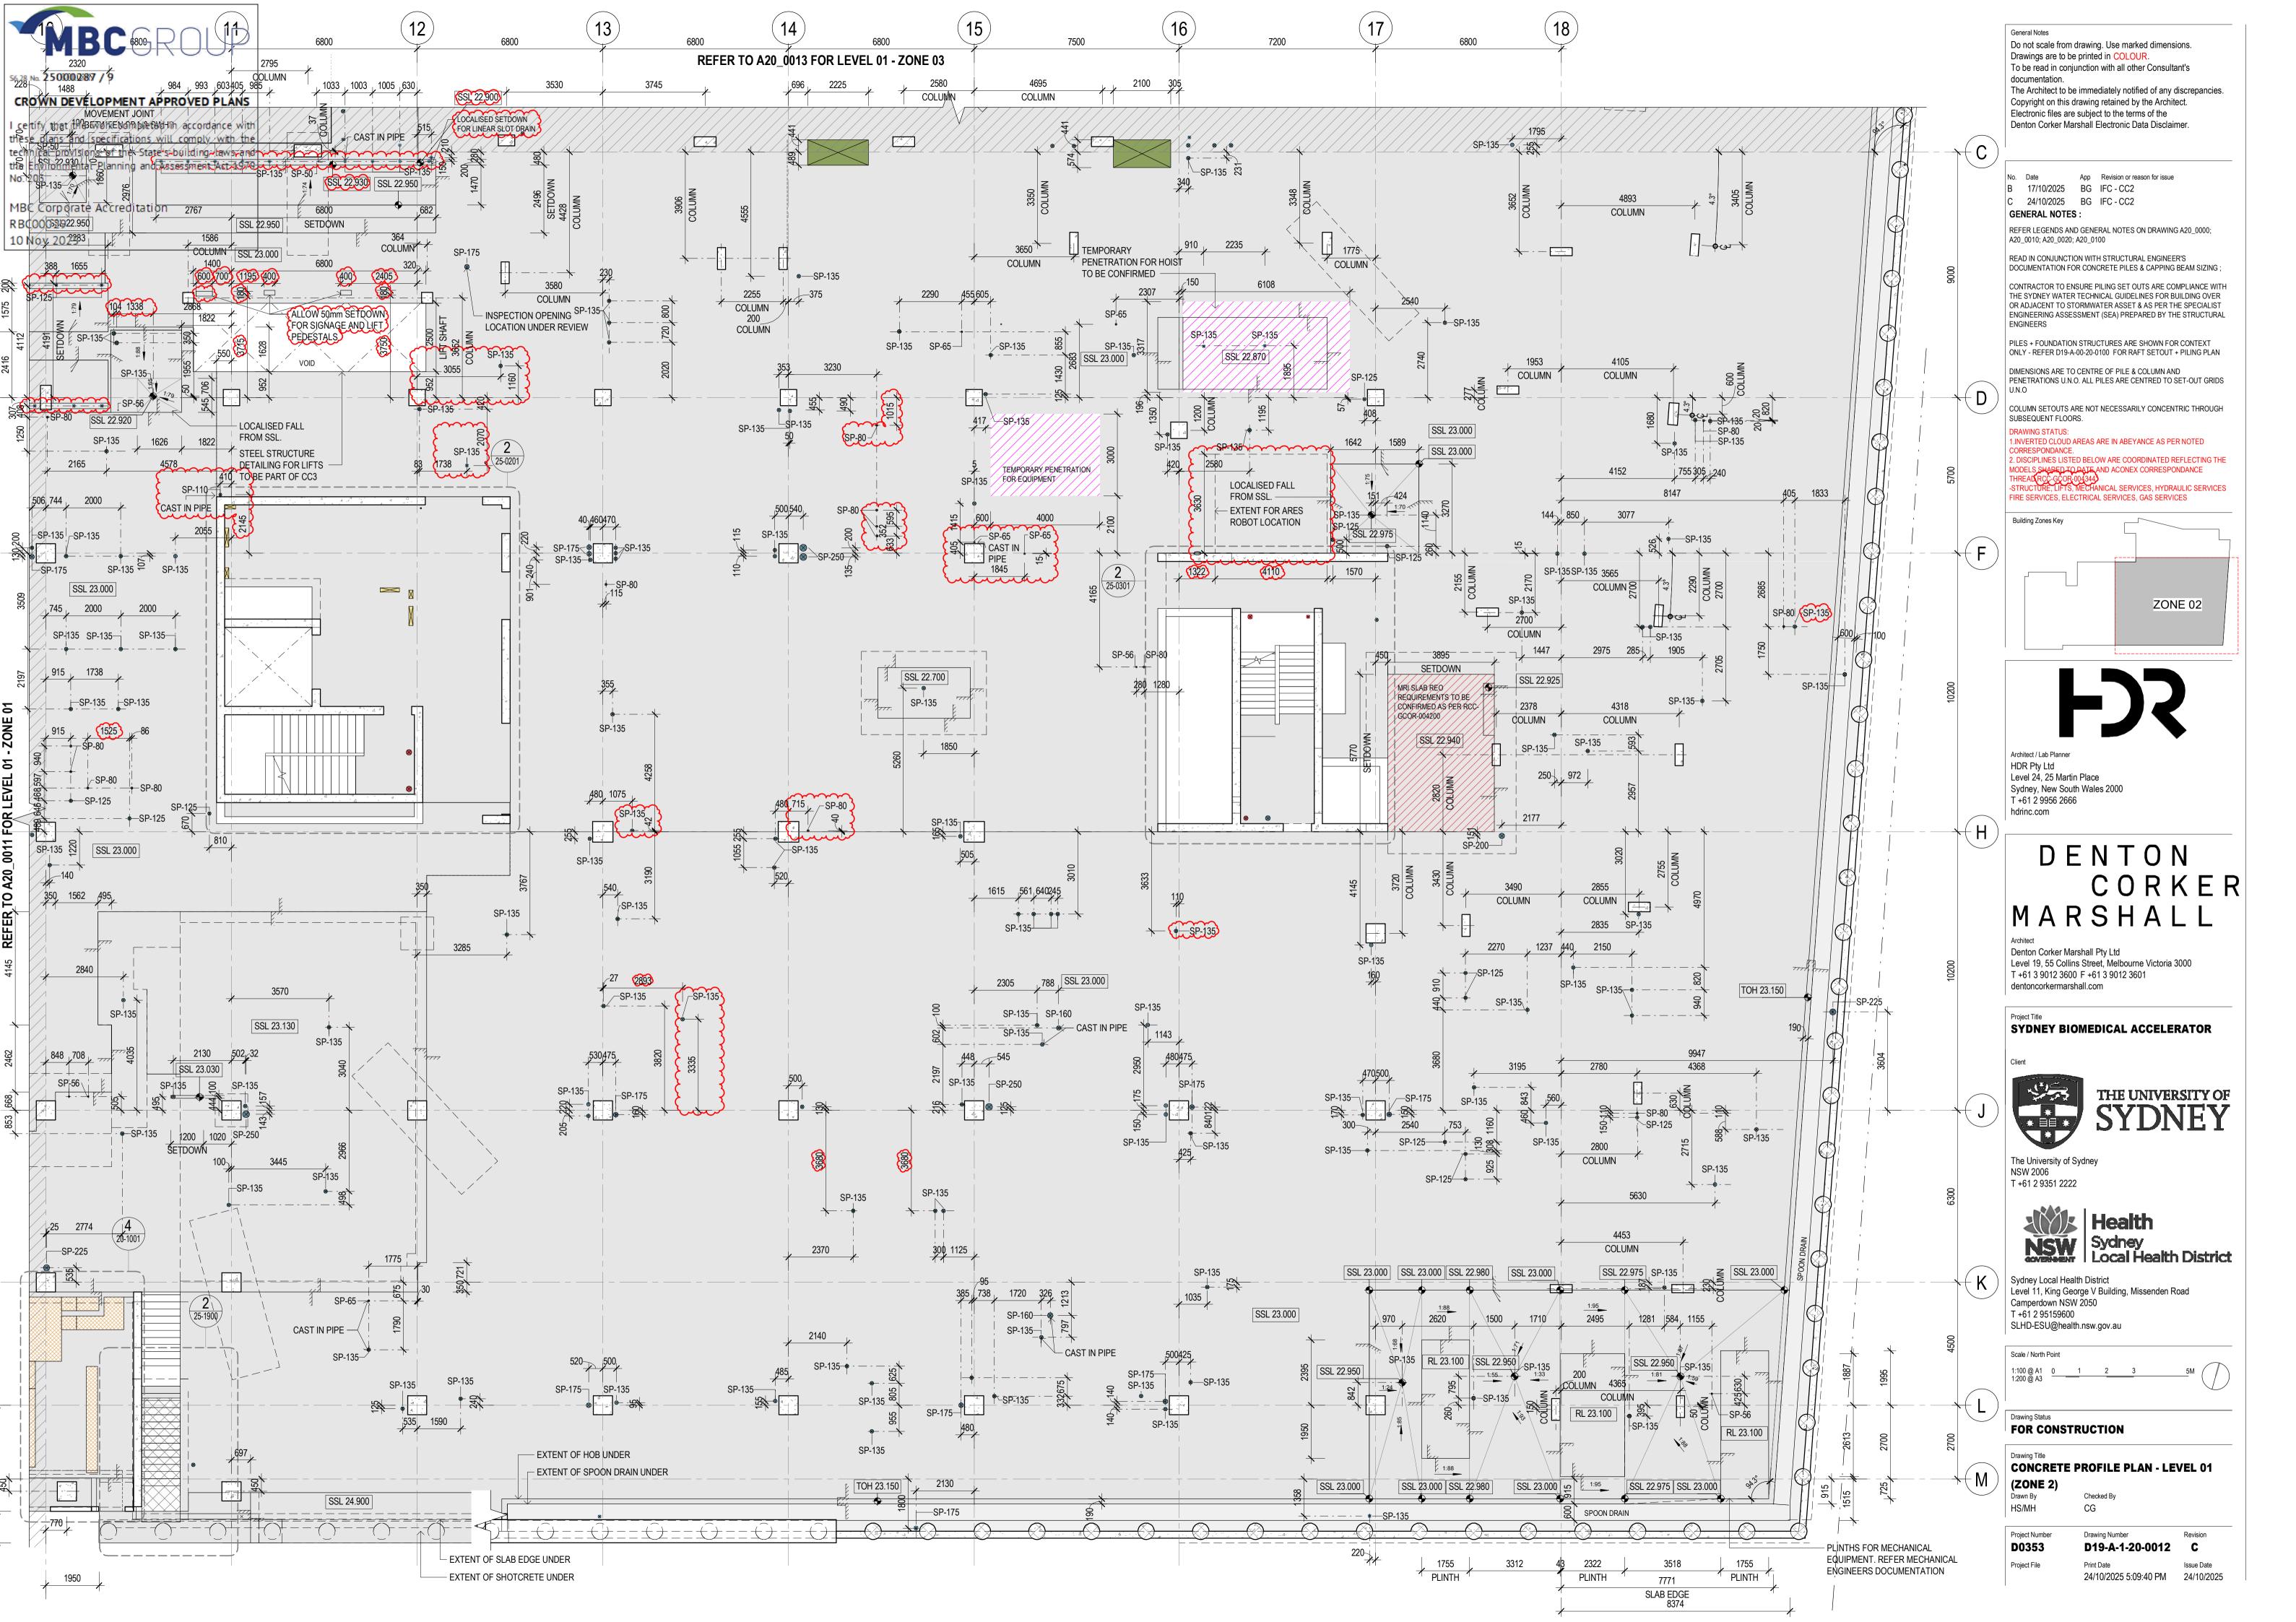
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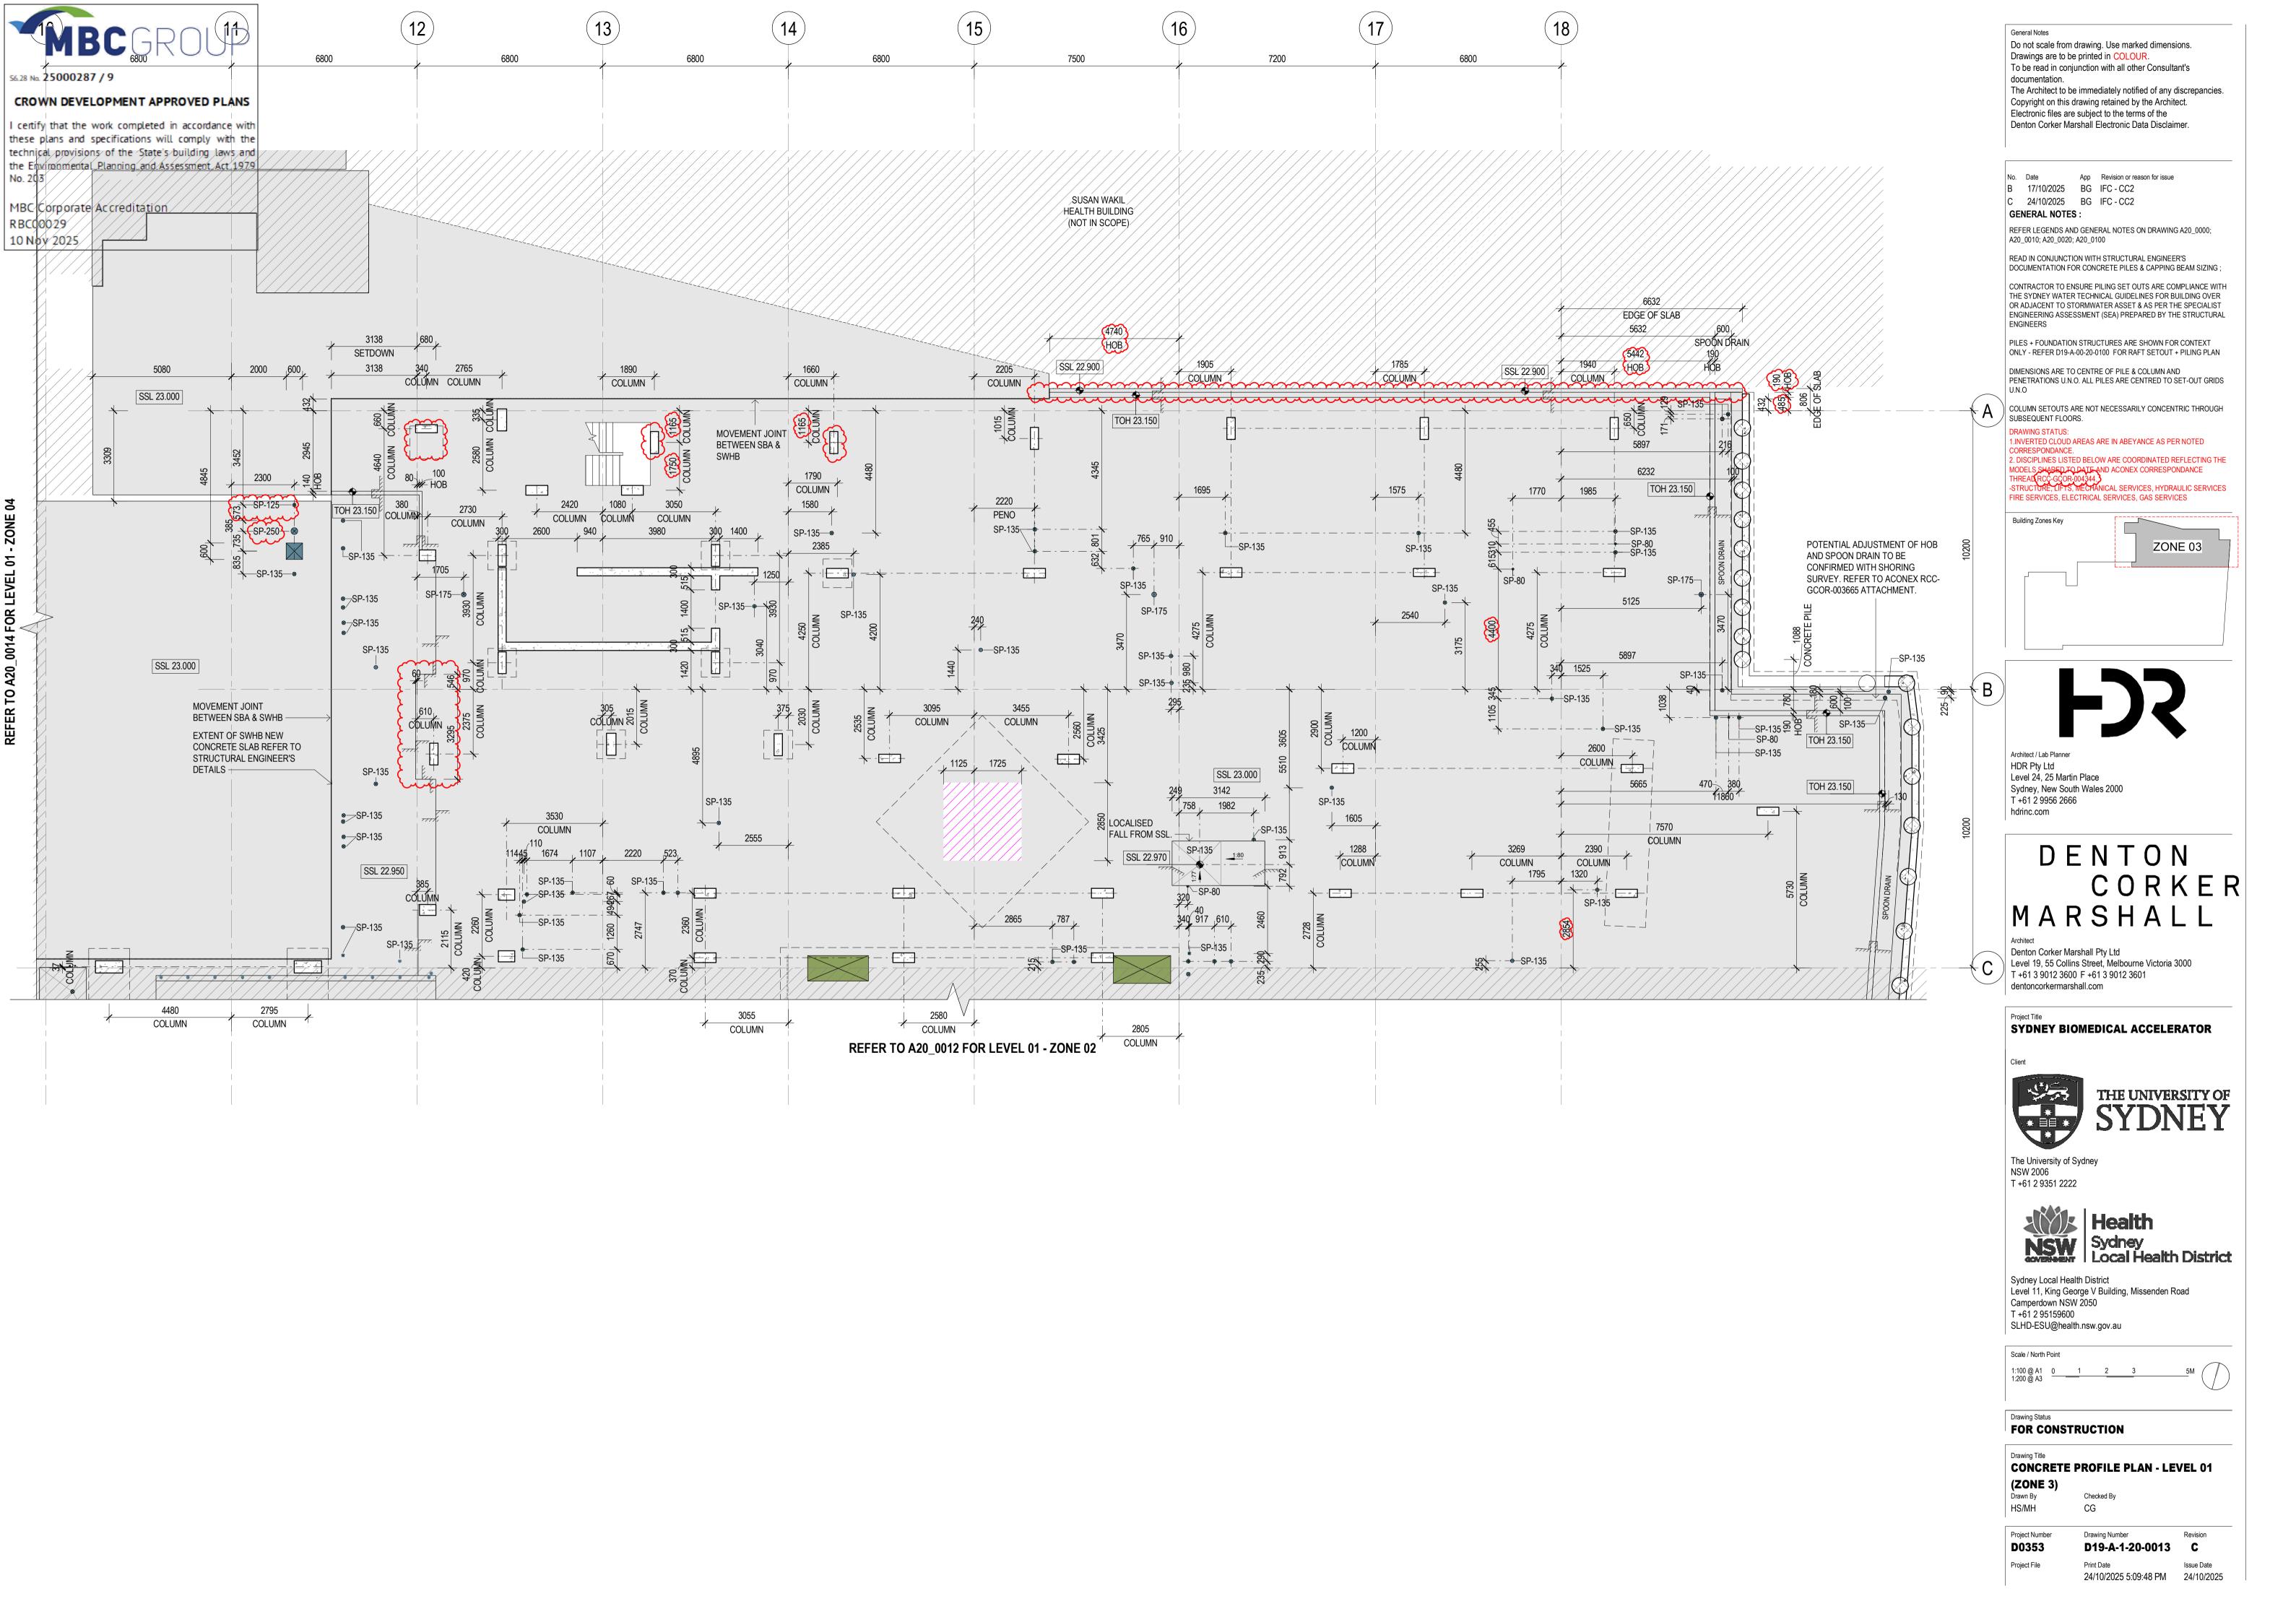
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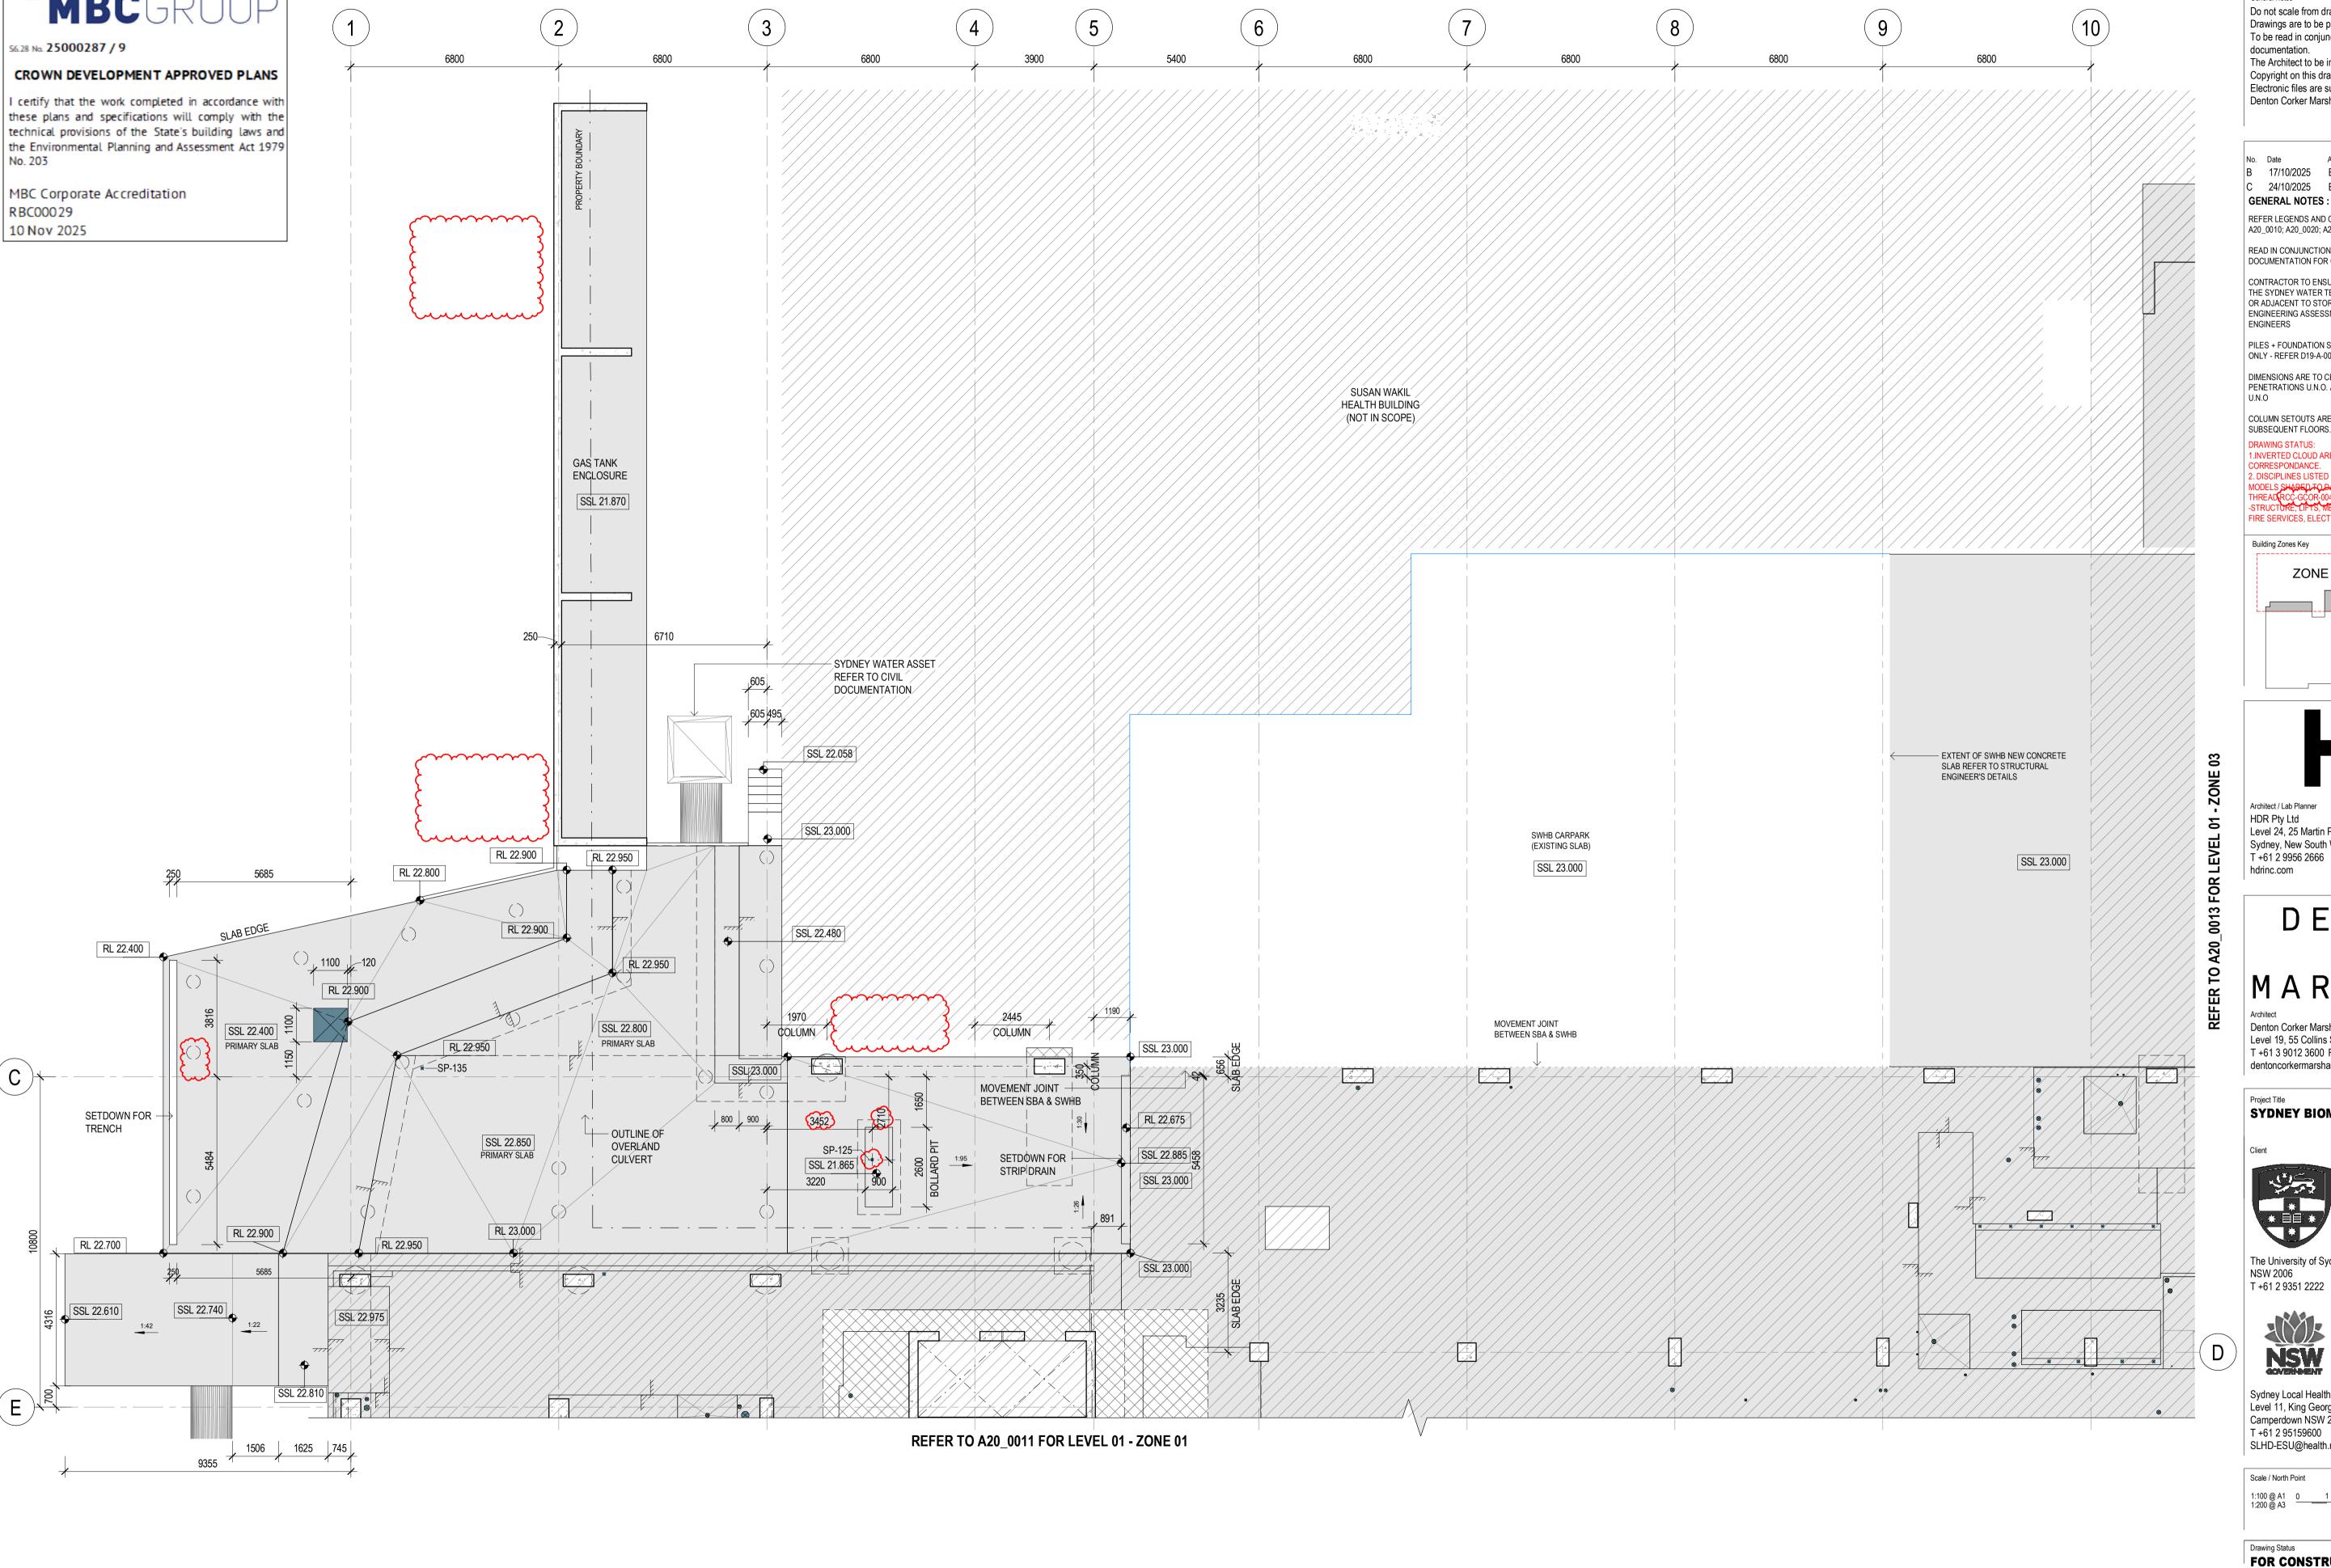
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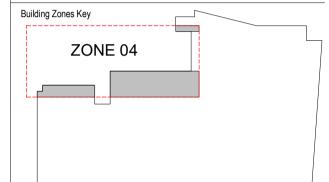
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THREAD RCC-GCOR-004344
-STRUCTURE, LIFTS, MECHANICAL SERVICES, HYDRAULIC SERVICES FIRE SERVICES, ELECTRICAL SERVICES, GAS SERVICES





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Scale / North Point

Drawing Status FOR CONSTRUCTION

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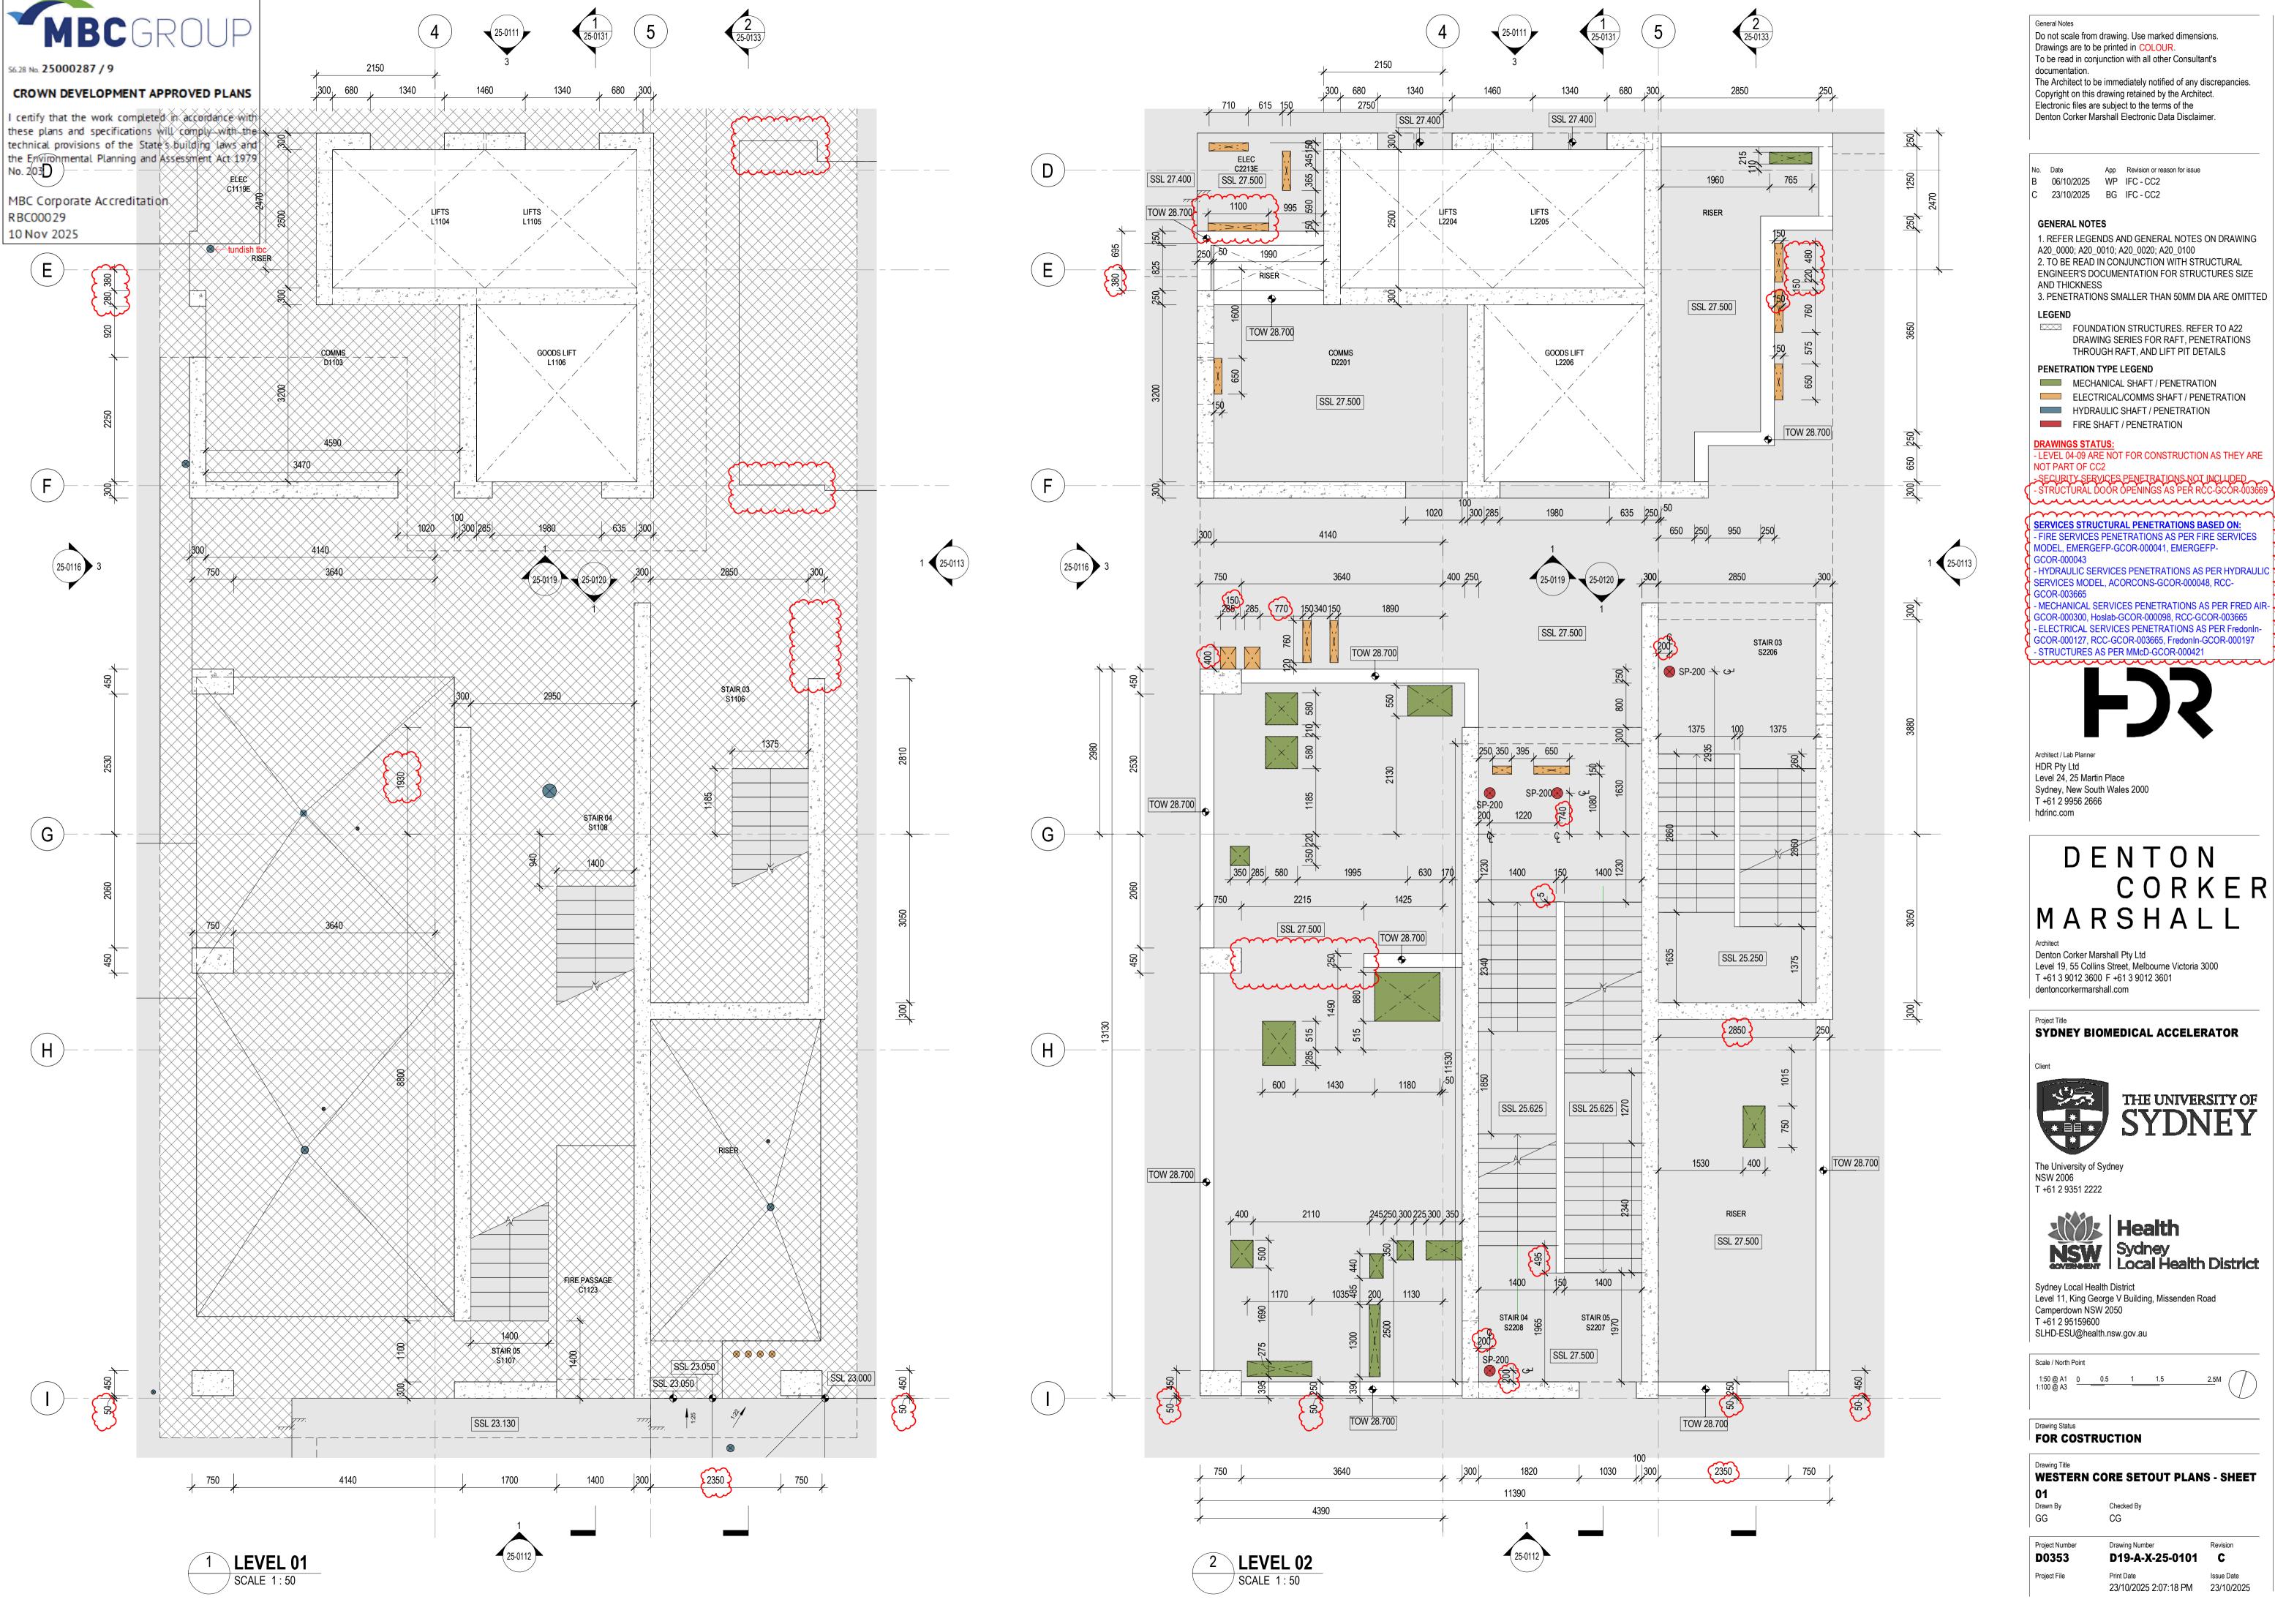
Project Number

D0353

CONCRETE PROFILE PLAN - LEVEL 01 (ZONE 4)

Drawing Number D19-A-1-20-0014 C

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1. REFER LEGENDS AND GENERAL NOTES ON DRAWING 2. TO BE READ IN CONJUNCTION WITH STRUCTURAL ENGINEER'S DOCUMENTATION FOR STRUCTURES SIZE

3. PENETRATIONS SMALLER THAN 50MM DIA ARE OMITTED

DRAWING SERIES FOR RAFT, PENETRATIONS

ELECTRICAL/COMMS SHAFT / PENETRATION

SERVICES STRUCTURAL PENETRATIONS BASED ON: - FIRE SERVICES PENETRATIONS AS PER FIRE SERVICES

- HYDRAULIC SERVICES PENETRATIONS AS PER HYDRAULIC SERVICES MODEL, ACORCONS-GCOR-000048, RCC-

- MECHANICAL SERVICES PENETRATIONS AS PER FRED AIR-GCOR-000300, Hoslab-GCOR-000098, RCC-GCOR-003665 - ELECTRICAL SERVICES PENETRATIONS AS PER Fredonin-GCOR-000127, RCC-GCOR-003665, FredonIn-GCOR-000197



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WESTERN CORE SETOUT PLANS - SHEET



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3. PENETRATIONS SMALLER THAN 50MM DIA ARE OMITTED

FOUNDATION STRUCTURES. REFER TO A22 DRAWING SERIES FOR RAFT, PENETRATIONS

MECHANICAL SHAFT / PENETRATION ELECTRICAL/COMMS SHAFT / PENETRATION

<u>DRAWINGS STATUS:</u>
- LEVEL 04-09 ARE NOT FOR CONSTRUCTION AS THEY ARE

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- MECHANICAL SERVICES PENETRATIONS AS PER FRED AIR-GCOR-000300, Hoslab-GCOR-000098, RCC-GCOR-003665 - ELECTRICAL SERVICES PENETRATIONS AS PER Fredonin-GCOR-000127, RCC-GCOR-003665, Fredonln-GCOR-000197 - STRUCTURES AS PER MMcD-GCOR-000421



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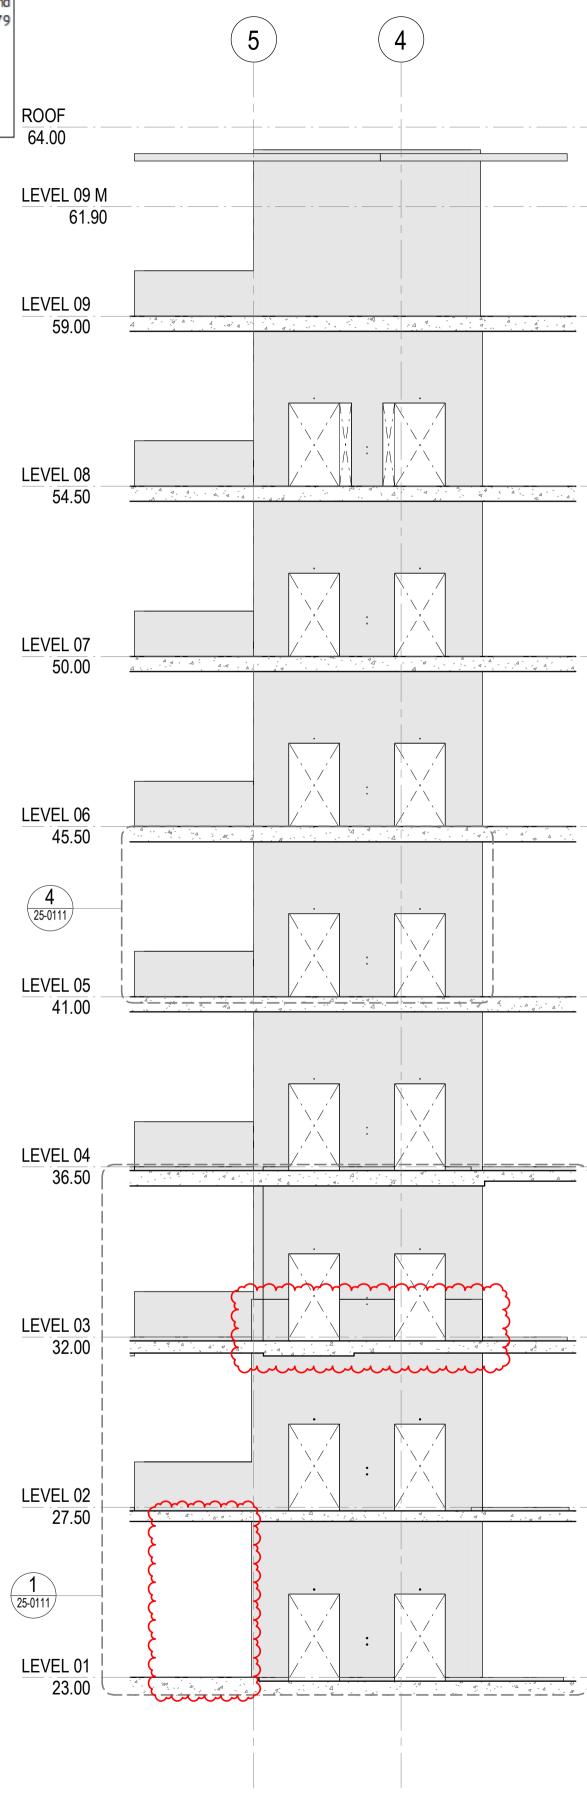
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CROWN DEVELOPMENT APPROVED PLANS


I certify that the work completed in accordance with these plans and specifications will comply with the technical provisions of the State's building laws and the Environmental Planning and Assessment Act 1979 No. 203

MBC Corporate Accreditation RBC00029

10 Nov 2025



NORTH ELEVATION 25-0101 SCALE 1:100

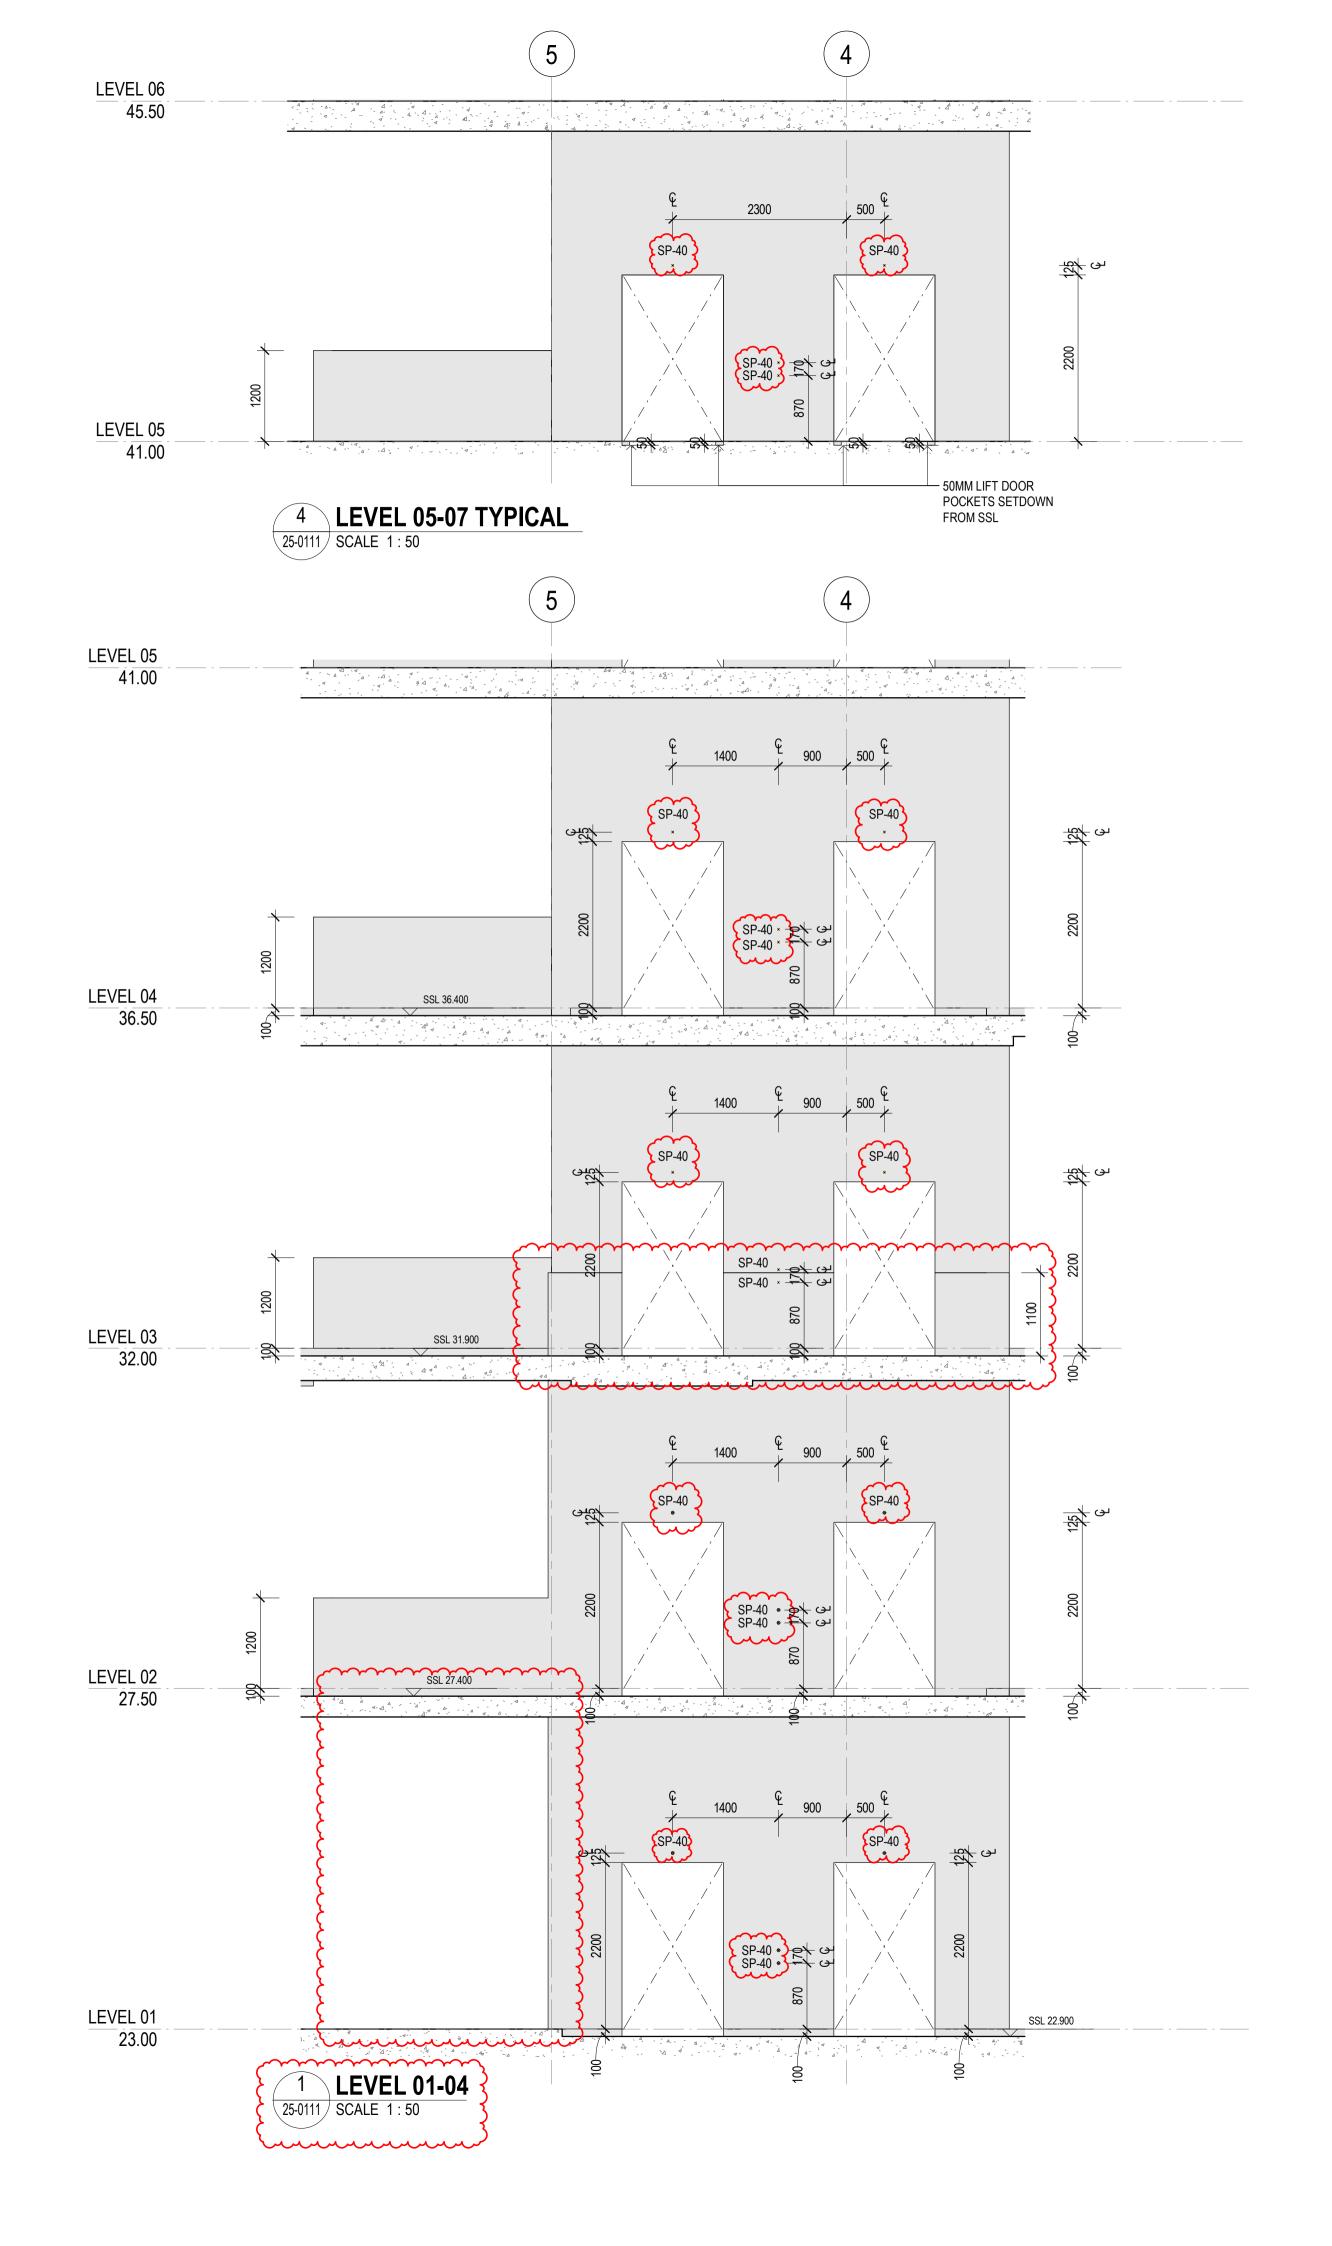

General Notes

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No. Date App Revision or reason for issue B 06/10/2025 WP IFC - CC2 C 23/10/2025 BG IFC - CC2

GENERAL NOTES

1. REFER LEGENDS AND GENERAL NOTES ON DRAWING A20_0000; A20_0010; A20_0020; A20_0100 2. TO BE READ IN CONJUNCTION WITH STRUCTURAL ENGINEER'S DOCUMENTATION FOR STRUCTURES SIZE AND THICKNESS

3. PENETRATIONS SMALLER THAN 50MM DIA ARE OMITTED

LEGEND

FOUNDATION STRUCTURES. REFER TO A22 DRAWING SERIES FOR RAFT, PENETRATIONS THROUGH RAFT, AND LIFT PIT DETAILS

PENETRATION TYPE LEGEND

MECHANICAL SHAFT / PENETRATION ELECTRICAL/COMMS SHAFT / PENETRATION HYDRAULIC SHAFT / PENETRATION

FIRE SHAFT / PENETRATION

DRAWINGS STATUS:
- LEVEL 04-09 ARE NOT FOR CONSTRUCTION AS THEY ARE NOT PART OF CC2

SERVICES STRUCTURAL PENETRATIONS BASED ON:
- FIRE SERVICES AS PER DCM-GCOR-000639 AND LATEST FIRE SERVICES MODEL - STRUCTURES AS PER MMcD-GCOR-000421

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Scale / North Point

1:50 @ A1 0 0.5 1 1.5 1:100 @ A3

Drawing Status FOR COSTRUCTION

WESTERN CORE SETOUT ELEVATIONS -SHEET 01

CG

Project Number D0353

GG

Drawing Number D19-A-X-25-0111 C


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CROWN DEVELOPMENT APPROVED PLANS


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MBC Corporate Accreditation

RBC00029 10 Nov 2025



25-0101 SCALE 1:100

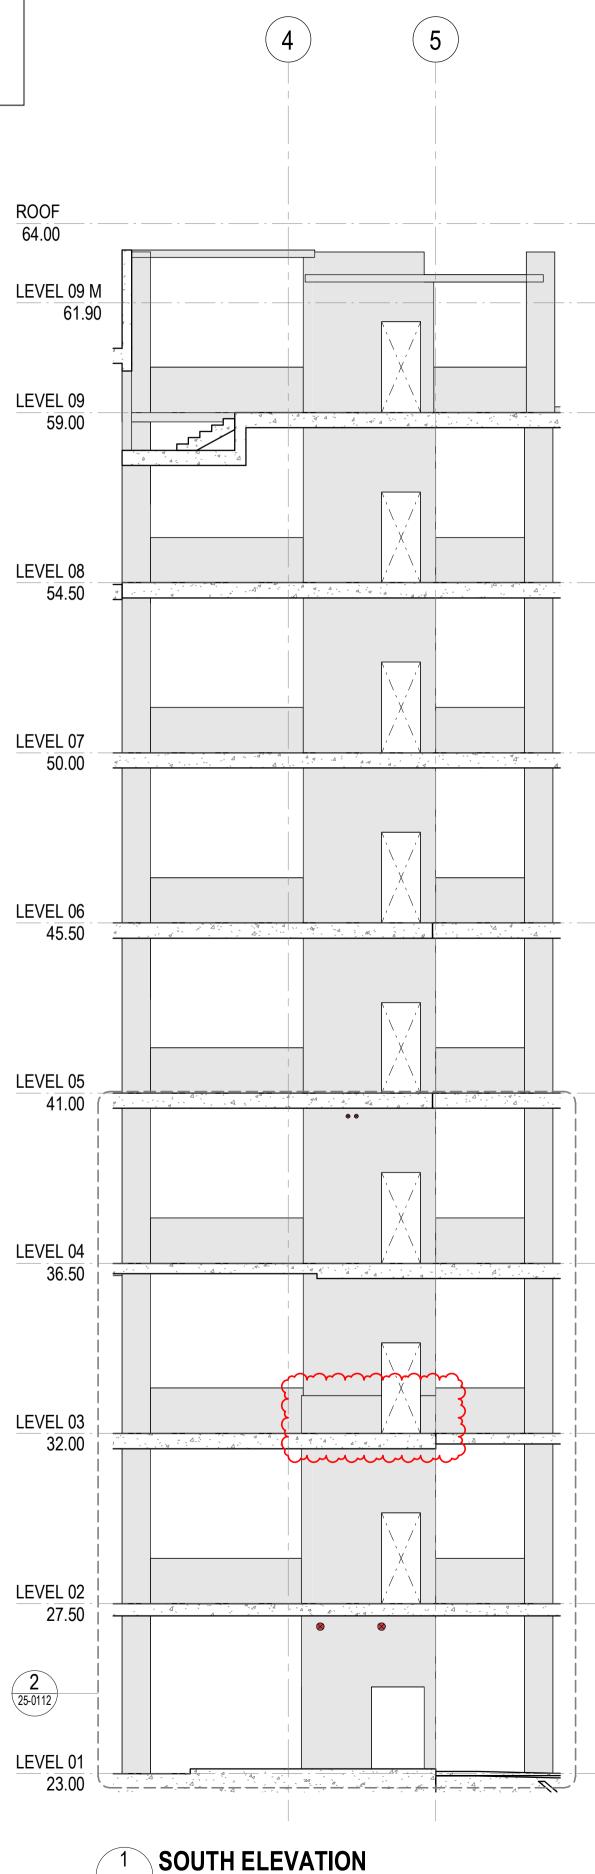
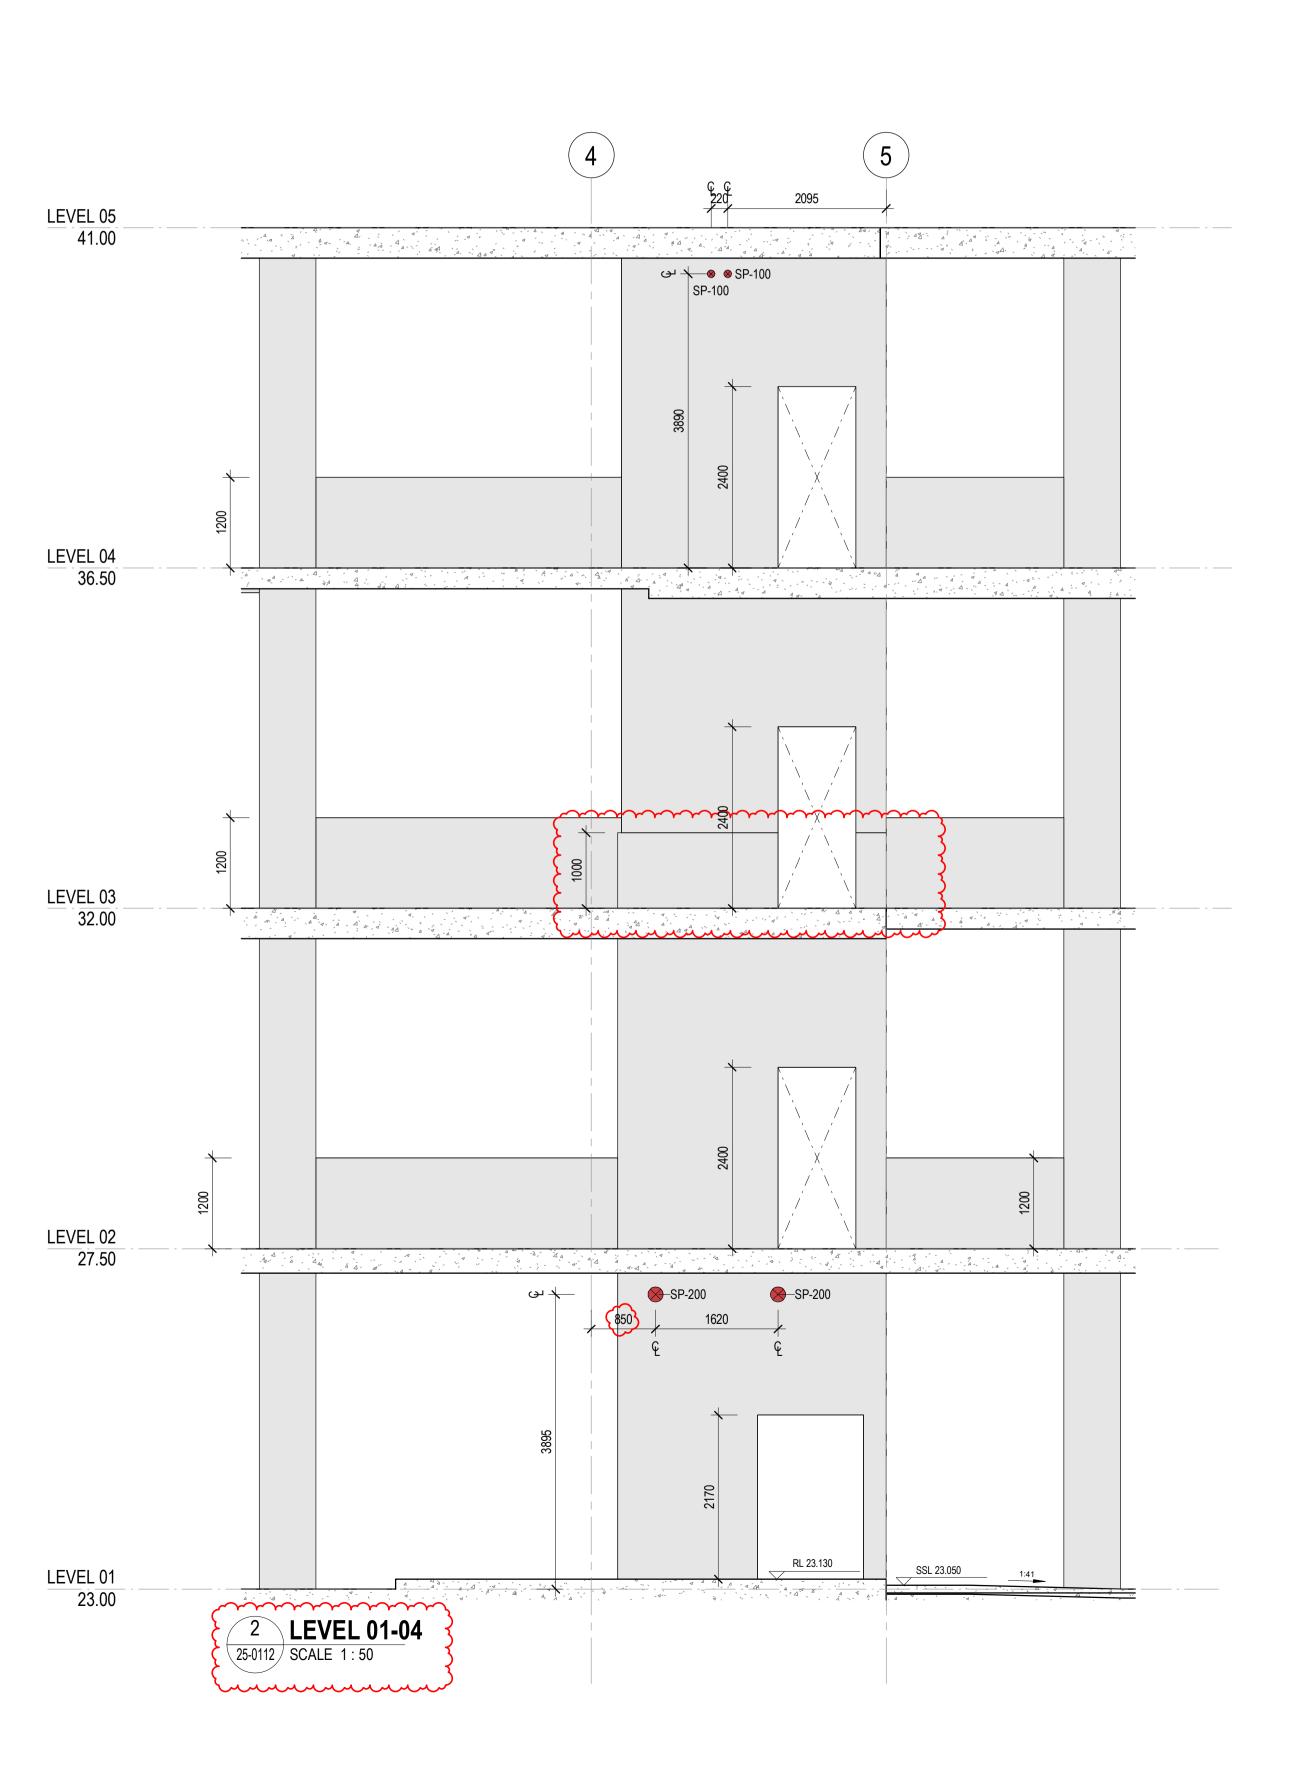
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FOUNDATION STRUCTURES. REFER TO A22 DRAWING SERIES FOR RAFT, PENETRATIONS THROUGH RAFT, AND LIFT PIT DETAILS

PENETRATION TYPE LEGEND

MECHANICAL SHAFT / PENETRATION ELECTRICAL/COMMS SHAFT / PENETRATION

HYDRAULIC SHAFT / PENETRATION FIRE SHAFT / PENETRATION

DRAWINGS STATUS:
- LEVEL 04-09 ARE NOT FOR CONSTRUCTION AS THEY ARE NOT PART OF CC2 - SECURITY SERVICES PENETRATIONS NOT INCLUDED - STRÚCTURÁL DOOR ÓPENINGS ÁS PER RCC-GCÓR-003669

SERVICES STRUCTURAL PENETRATIONS BASED ON:

- FIRE SERVICES PENETRATIONS AS PER FIRE SERVICES MODEL, EMERGEFP-GCOR-000041, EMERGEFP-GCOR-000043



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Drawing Status FOR COSTRUCTION


WESTERN CORE SETOUT ELEVATIONS -SHEET 02

Project Number Drawing Number D0353

GG

D19-A-X-25-0112 C

23/10/2025 2:07:34 PM 23/10/2025

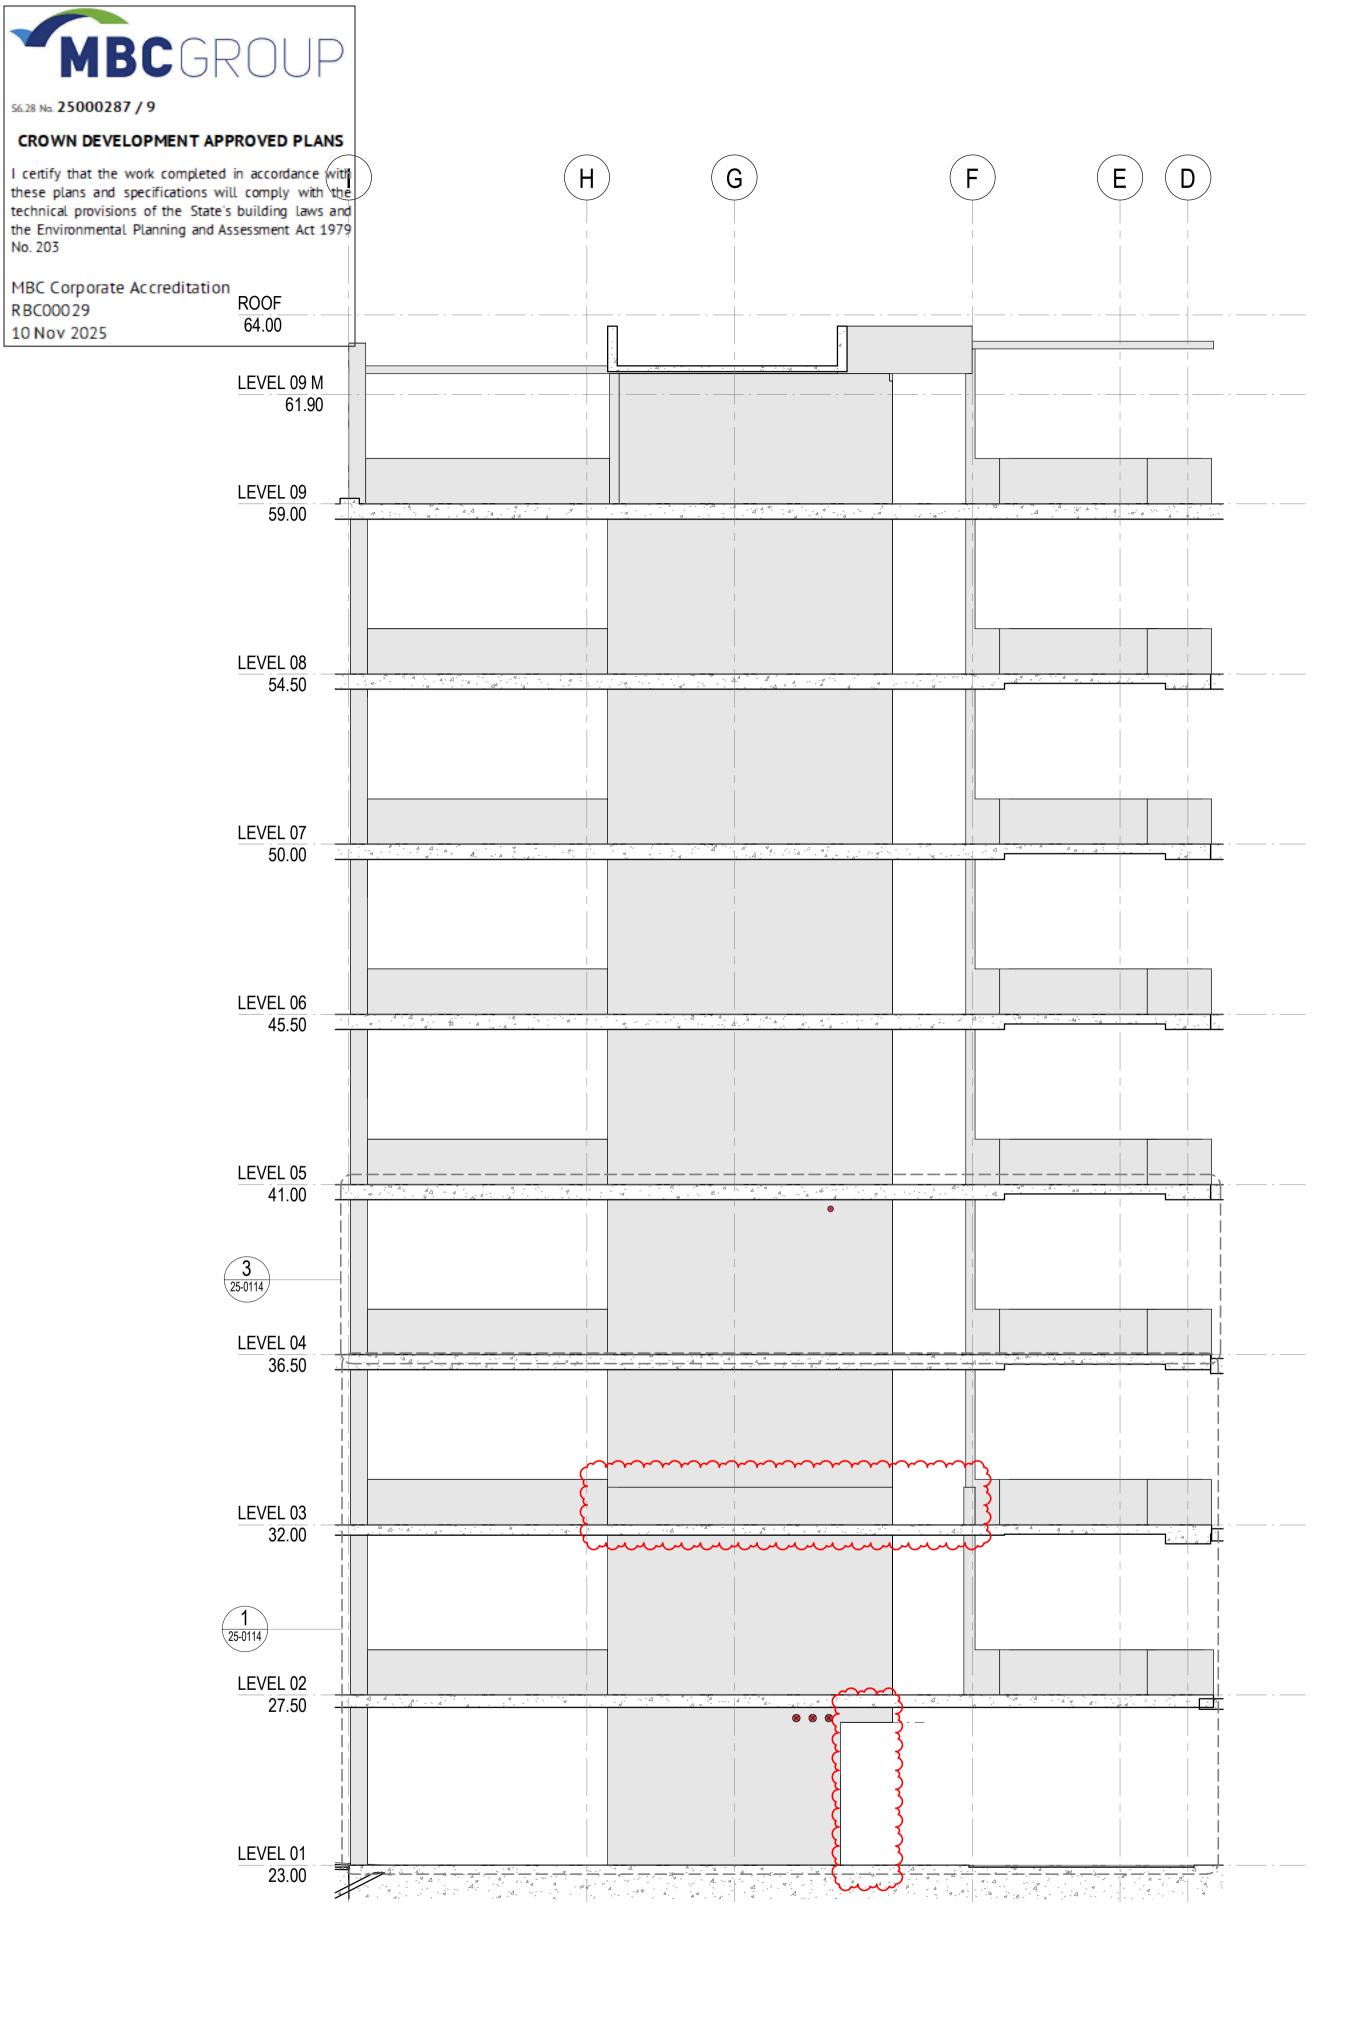

EAST ELEVATION SCALE 1:100

No. 203

RBC00029

10 Nov 2025

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No. Date App Revision or reason for issue B 06/10/2025 WP IFC - CC2 C 23/10/2025 BG IFC - CC2

GENERAL NOTES

1. REFER LEGENDS AND GENERAL NOTES ON DRAWING A20 0000; A20 0010; A20 0020; A20 0100 2. TO BE READ IN CONJUNCTION WITH STRUCTURAL ENGINEER'S DOCUMENTATION FOR STRUCTURES SIZE AND THICKNESS

3. PENETRATIONS SMALLER THAN 50MM DIA ARE OMITTED

LEGEND

FOUNDATION STRUCTURES. REFER TO A22 DRAWING SERIES FOR RAFT, PENETRATIONS THROUGH RAFT, AND LIFT PIT DETAILS

PENETRATION TYPE LEGEND

- MECHANICAL SHAFT / PENETRATION ELECTRICAL/COMMS SHAFT / PENETRATION
- HYDRAULIC SHAFT / PENETRATION FIRE SHAFT / PENETRATION

DRAWINGS STATUS:
- LEVEL 04-09 ARE NOT FOR CONSTRUCTION AS THEY ARE NOT PART OF CC2

~SEGURITY-SERVIGES-PENETRATIONS-NOT/INGLUDED ~~ - STRUCTURAL DOOR OPENINGS AS PER RCC-GCOR-003669

SERVICES STRUCTURAL PENETRATIONS BASED ON: - STRUCTURES AS PER MMcD-GCOR-000421



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Scale / North Point 1:50 @ A1 0 0.5 1 1.5 2.5M 1:100 @ A3

Drawing Status FOR COSTRUCTION

WESTERN CORE SETOUT ELEVATIONS -SHEET 03

GG CG

Project Number Drawing Number D0353


Revision D19-A-X-25-0113

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CROWN DEVELOPMENT APPROVED PLANS


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MBC Corporate Accreditation RBC00029 10 Nov 2025



EAST ELEVATION - LEVEL 04-08 - TYPICAL

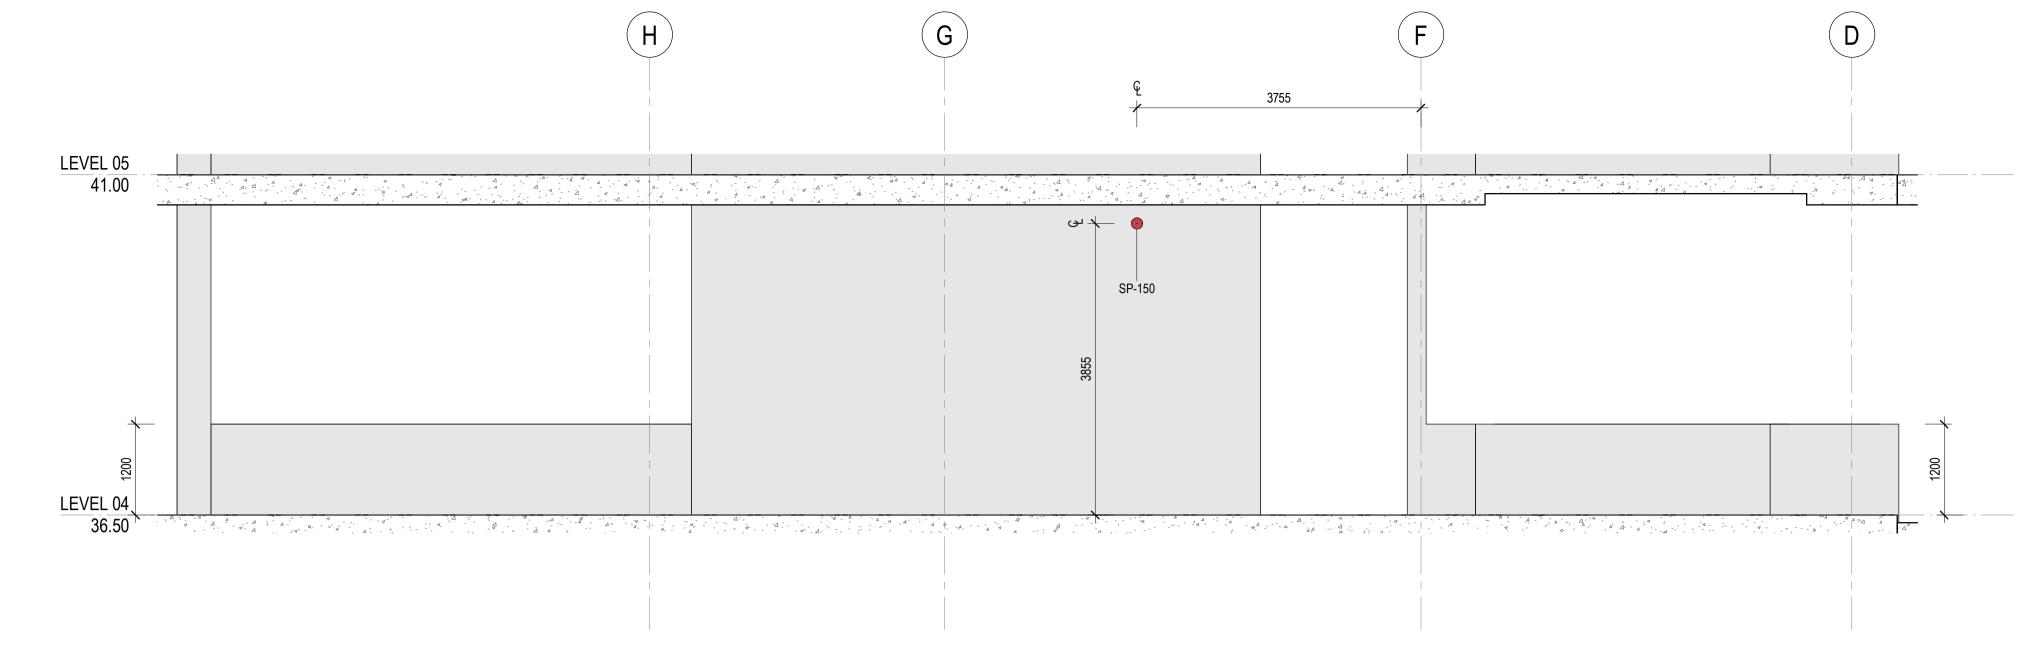25-0113 | SCALE 1 : 50

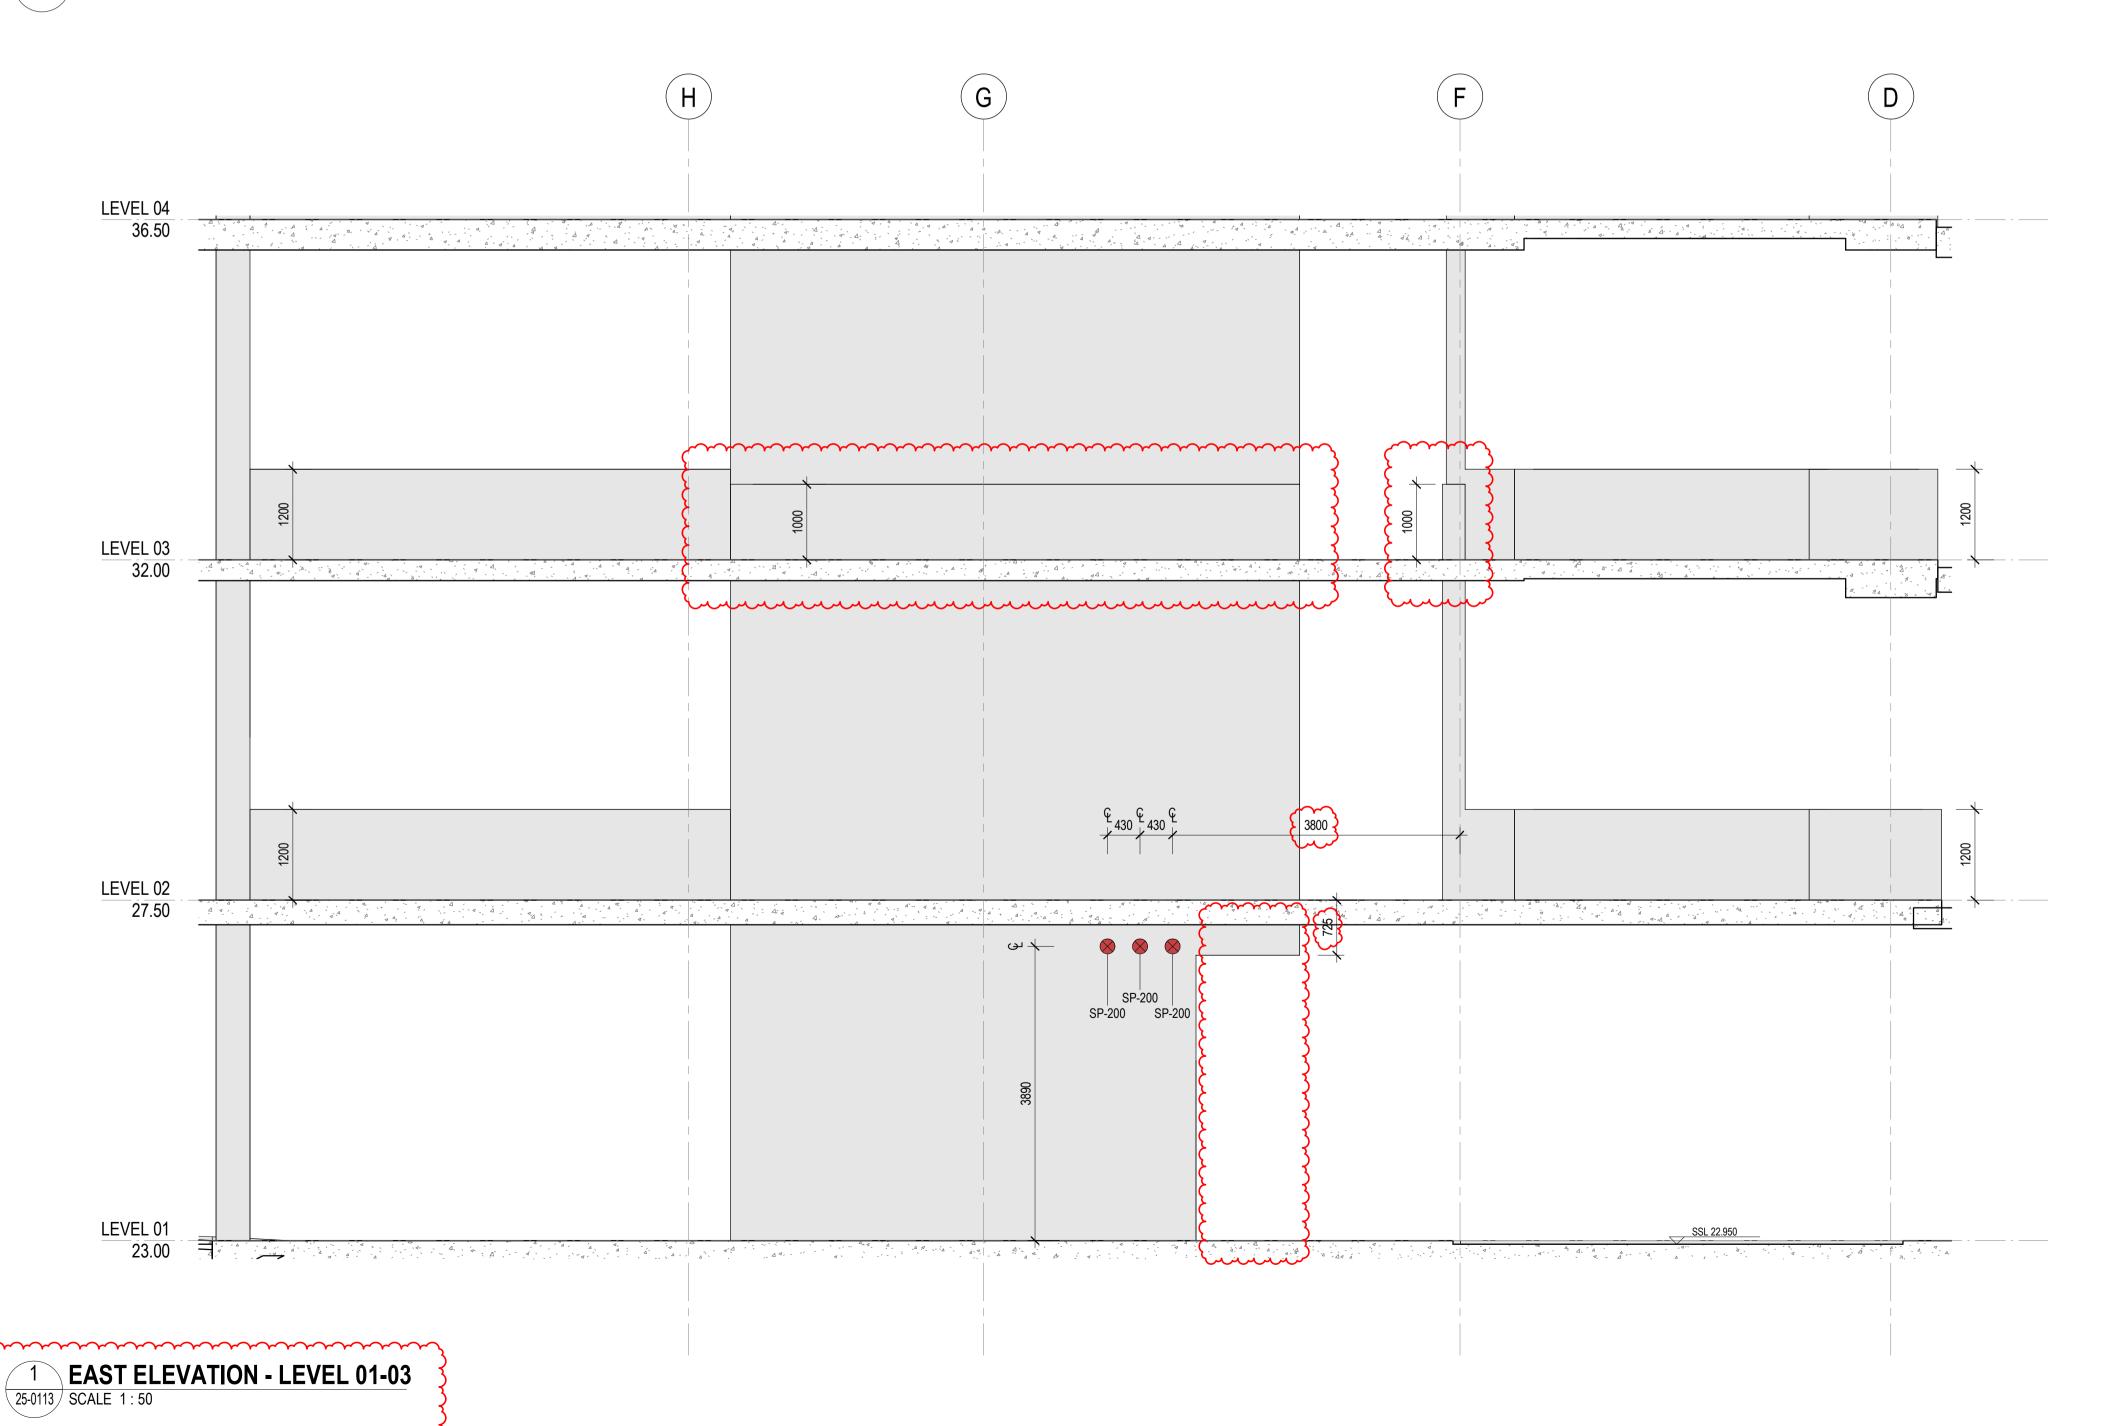

General Notes

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App Revision or reason for issue B 06/10/2025 WP IFC - CC2 C 23/10/2025 BG IFC - CC2

GENERAL NOTES

1. REFER LEGENDS AND GENERAL NOTES ON DRAWING A20_0000; A20_0010; A20_0020; A20_0100 2. TO BE READ IN CONJUNCTION WITH STRUCTURAL ENGINEER'S DOCUMENTATION FOR STRUCTURES SIZE

AND THICKNESS 3. PENETRATIONS SMALLER THAN 50MM DIA ARE OMITTED

LEGEND

FOUNDATION STRUCTURES. REFER TO A22 DRAWING SERIES FOR RAFT, PENETRATIONS THROUGH RAFT, AND LIFT PIT DETAILS

PENETRATION TYPE LEGEND

MECHANICAL SHAFT / PENETRATION ELECTRICAL/COMMS SHAFT / PENETRATION

HYDRAULIC SHAFT / PENETRATION FIRE SHAFT / PENETRATION

DRAWINGS STATUS:

- LEVEL 04-09 ARE NOT FOR CONSTRUCTION AS THEY ARE NOT PART OF CC2 - SECURITY SERVICES PENETRATIONS NOT INCLUDED - STRÚCTURÁL DOOR OPENINGS AS PER RCC-GCOR-003669

SERVICES STRUCTURAL PENETRATIONS BASED ON: - FIRE SERVICES PENETRATIONS AS MMcD-GCOR-000421 - STRUCTURES AS PER MMcD-GCOR-000421



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Scale / North Point 1:50 @ A1 0 0.5 1 1.5 2.5M 1:100 @ A3

Drawing Status FOR COSTRUCTION

WESTERN CORE SETOUT ELEVATIONS -SHEET 04

GG Project Number D0353

Drawing Number

D19-A-X-25-0114 C 23/10/2025 2:10:16 PM 23/10/2025



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App Revision or reason for issue B 06/10/2025 WP IFC - CC2 C 23/10/2025 BG IFC - CC2

GENERAL NOTES

1. REFER LEGENDS AND GENERAL NOTES ON DRAWING A20 0000; A20 0010; A20 0020; A20 0100 2. TO BE READ IN CONJUNCTION WITH STRUCTURAL ENGINEER'S DOCUMENTATION FOR STRUCTURES SIZE

AND THICKNESS 3. PENETRATIONS SMALLER THAN 50MM DIA ARE OMITTED

LEGEND

FOUNDATION STRUCTURES. REFER TO A22 DRAWING SERIES FOR RAFT, PENETRATIONS THROUGH RAFT, AND LIFT PIT DETAILS

PENETRATION TYPE LEGEND

MECHANICAL SHAFT / PENETRATION ELECTRICAL/COMMS SHAFT / PENETRATION

FIRE SHAFT / PENETRATION

HYDRAULIC SHAFT / PENETRATION DRAWINGS STATUS:
- LEVEL 04-09 ARE NOT FOR CONSTRUCTION AS THEY ARE

NOT PART OF CC2

SERVICES STRUCTURAL PENETRATIONS BASED ON: - ELECTRICAL SERVICES PENETRATIONS AS PER Fredonin-GCOR-000127, RCC-GCOR-003665, FredonIn-GCOR-000205



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Local Health District

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1:50 @ A1 0 0.5 1 1.5 2.5M 1:100 @ A3

Drawing Status FOR COSTRUCTION

Scale / North Point

GG

D0353

WESTERN CORE SETOUT ELEVATIONS -SHEET 06

Project Number


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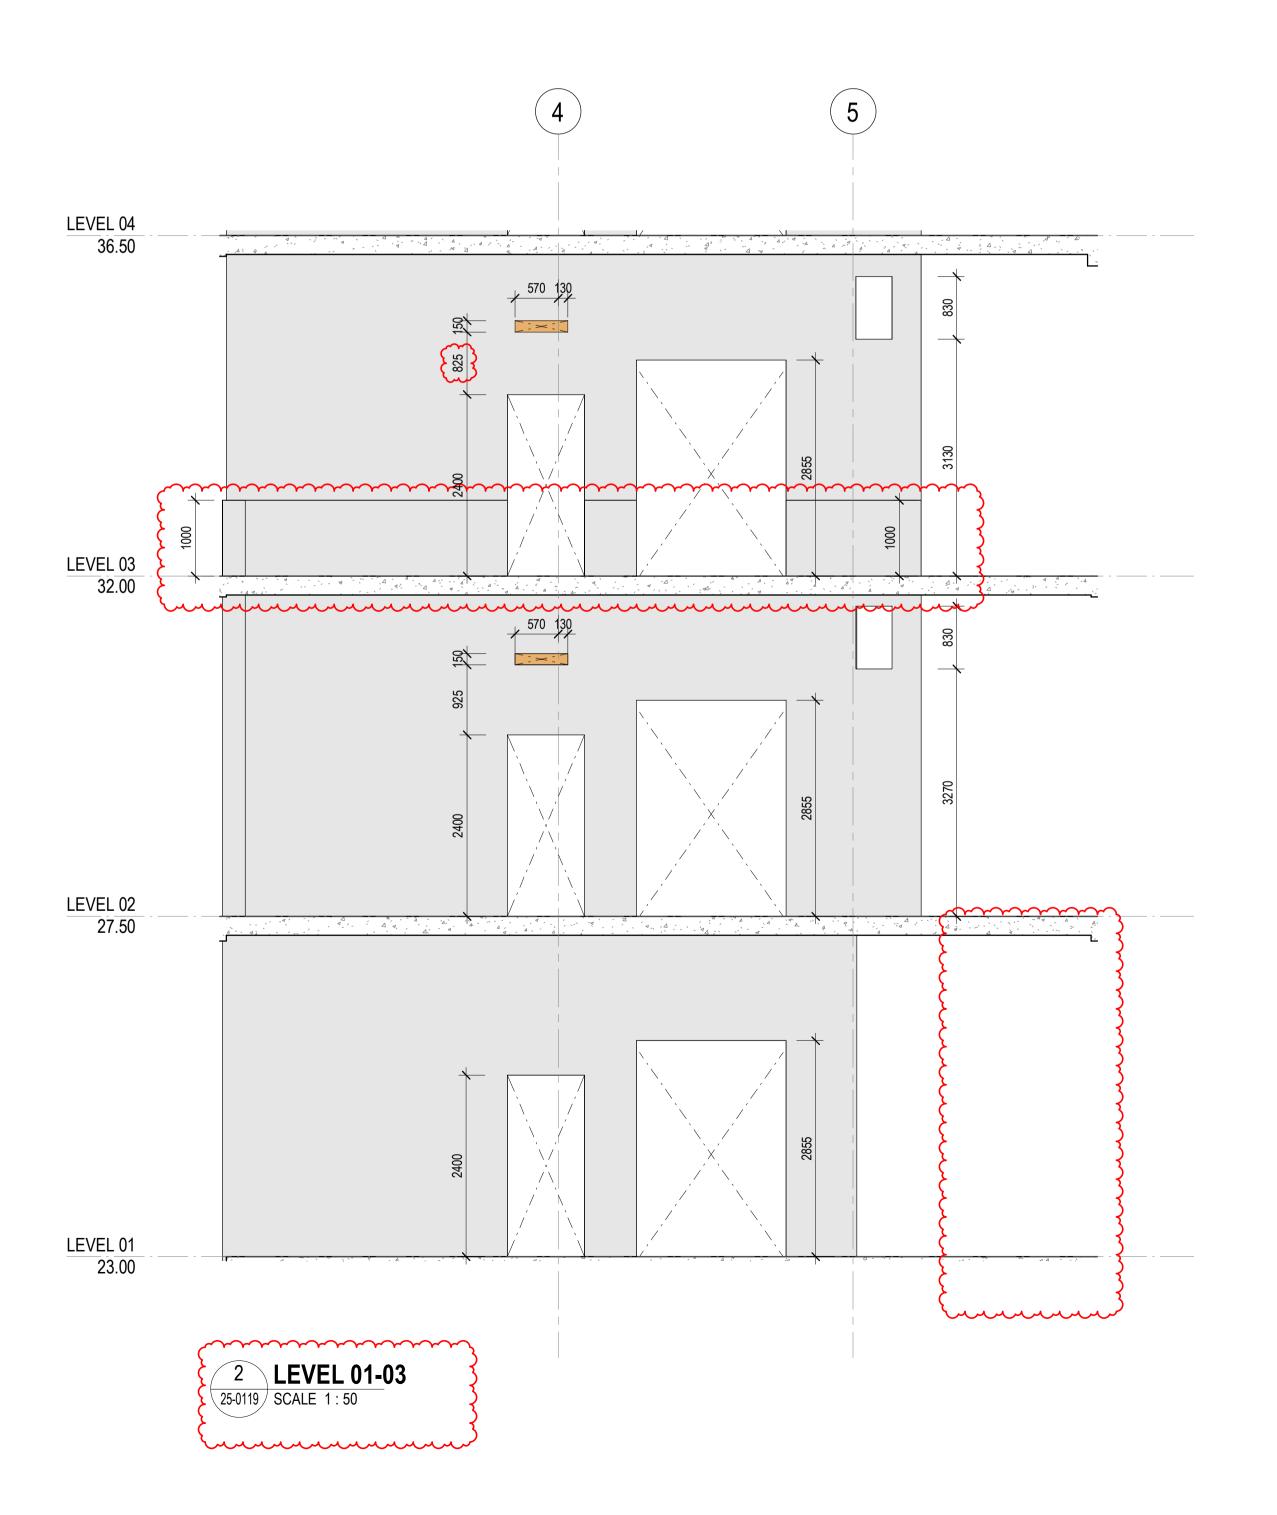
CROWN DEVELOPMENT APPROVED PLANS

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INTERNAL SOUTH ELEVATION 25-0101 SCALE 1:100



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No. Date App Revision or reason for issue B 06/10/2025 WP IFC - CC2 C 23/10/2025 BG IFC - CC2

GENERAL NOTES

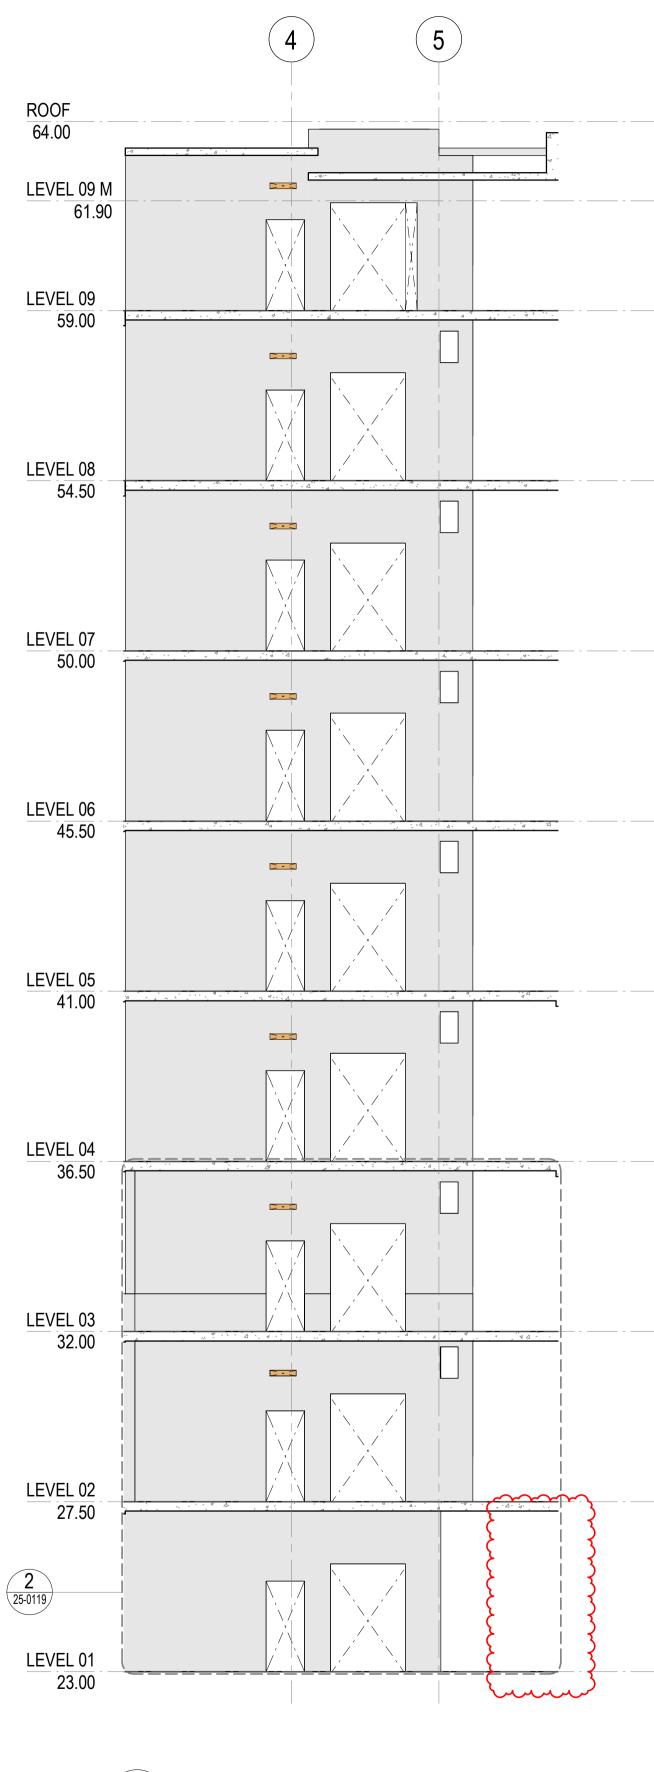1. REFER LEGENDS AND GENERAL NOTES ON DRAWING A20_0000; A20_0010; A20_0020; A20_0100 2. TO BE READ IN CONJUNCTION WITH STRUCTURAL ENGINEER'S DOCUMENTATION FOR STRUCTURES SIZE

AND THICKNESS 3. PENETRATIONS SMALLER THAN 50MM DIA ARE OMITTED

LEGEND

FOUNDATION STRUCTURES. REFER TO A22 DRAWING SERIES FOR RAFT, PENETRATIONS THROUGH RAFT, AND LIFT PIT DETAILS

PENETRATION TYPE LEGEND

MECHANICAL SHAFT / PENETRATION ELECTRICAL/COMMS SHAFT / PENETRATION HYDRAULIC SHAFT / PENETRATION

FIRE SHAFT / PENETRATION

DRAWINGS STATUS:
- LEVEL 04-09 ARE NOT FOR CONSTRUCTION AS THEY ARE NOT PART OF CC2

SERVICES STRUCTURAL PENETRATIONS BASED ON:
- MECHANICAL SERVICES PENETRATIONS AS PER FRED
AIR-GCOR-000300, FRED AIR-GCOR-000246, RCC-GCOR-003665

- ELECTRICAL SERVICES PENETRATIONS AS PER ELECTRICAL SERVICES MODEL AND RCC-GCOR-003665 - STRUCTURES AS PER MMcD-GCOR-000421



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1:50 @ A1 0 0.5 1 1.5 2.5M 1:100 @ A3

SLHD-ESU@health.nsw.gov.au Scale / North Point

Drawing Status FOR COSTRUCTION

WESTERN CORE SETOUT ELEVATIONS -

SHEET 09 GG CG

Project Number Drawing Number


D0353 D19-A-X-25-0119 23/10/2025 2:10:21 PM 23/10/2025

CROWN DEVELOPMENT APPROVED PLANS


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10 Nov 2025



INTERNAL NORTH ELEVATION 25-0101 SCALE 1:100

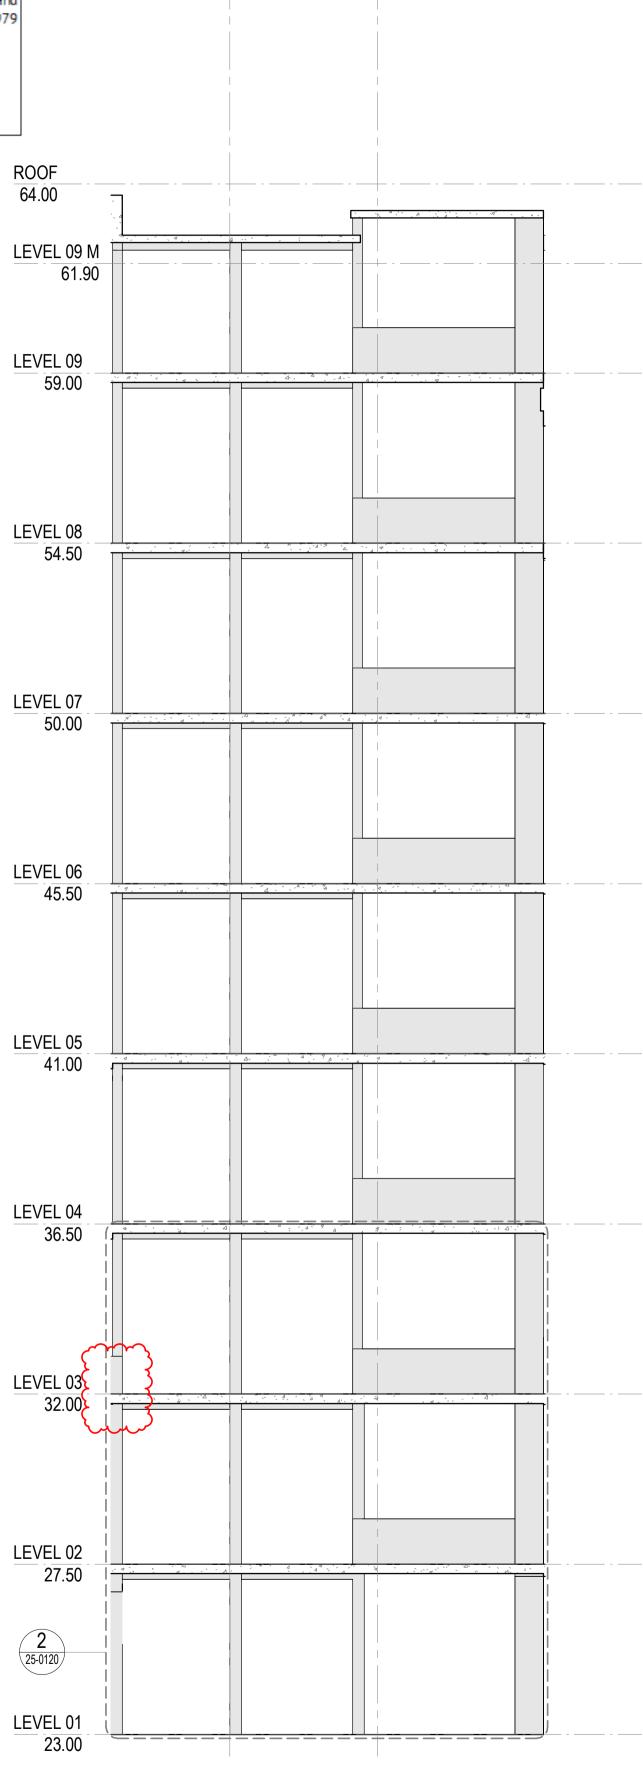

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No. Date App Revision or reason for issue B 06/10/2025 WP IFC - CC2 C 23/10/2025 BG IFC - CC2

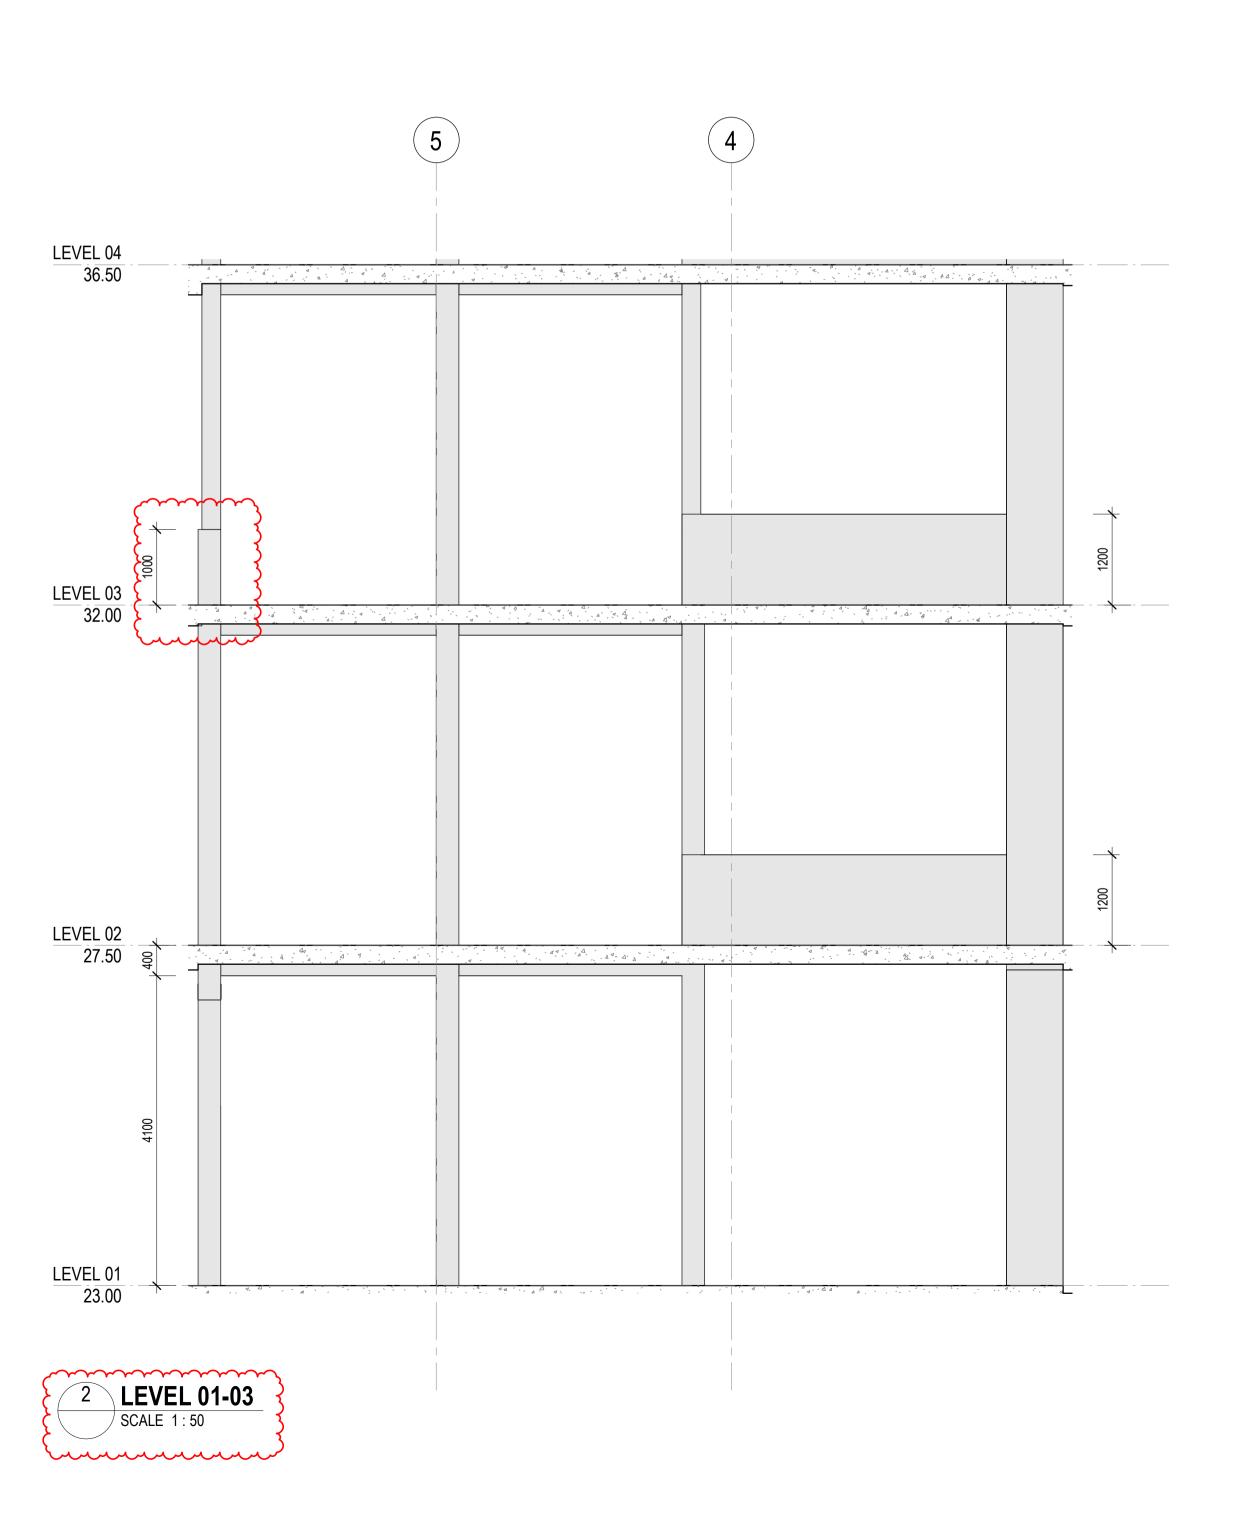GENERAL NOTES

1. REFER LEGENDS AND GENERAL NOTES ON DRAWING A20_0000; A20_0010; A20_0020; A20_0100 2. TO BE READ IN CONJUNCTION WITH STRUCTURAL ENGINEER'S DOCUMENTATION FOR STRUCTURES SIZE

AND THICKNESS 3. PENETRATIONS SMALLER THAN 50MM DIA ARE OMITTED

LEGEND

FOUNDATION STRUCTURES. REFER TO A22 DRAWING SERIES FOR RAFT, PENETRATIONS THROUGH RAFT, AND LIFT PIT DETAILS

PENETRATION TYPE LEGEND

MECHANICAL SHAFT / PENETRATION ELECTRICAL/COMMS SHAFT / PENETRATION HYDRAULIC SHAFT / PENETRATION

FIRE SHAFT / PENETRATION

DRAWINGS STATUS:
- LEVEL 04-09 ARE NOT FOR CONSTRUCTION AS THEY ARE NOT PART OF CC2 - SECURITY SERVICES PENETRATIONS NOT INCLUDED - STRUCTURÂL DOOR OPENINGS AS PER RCC-GCOR-003669



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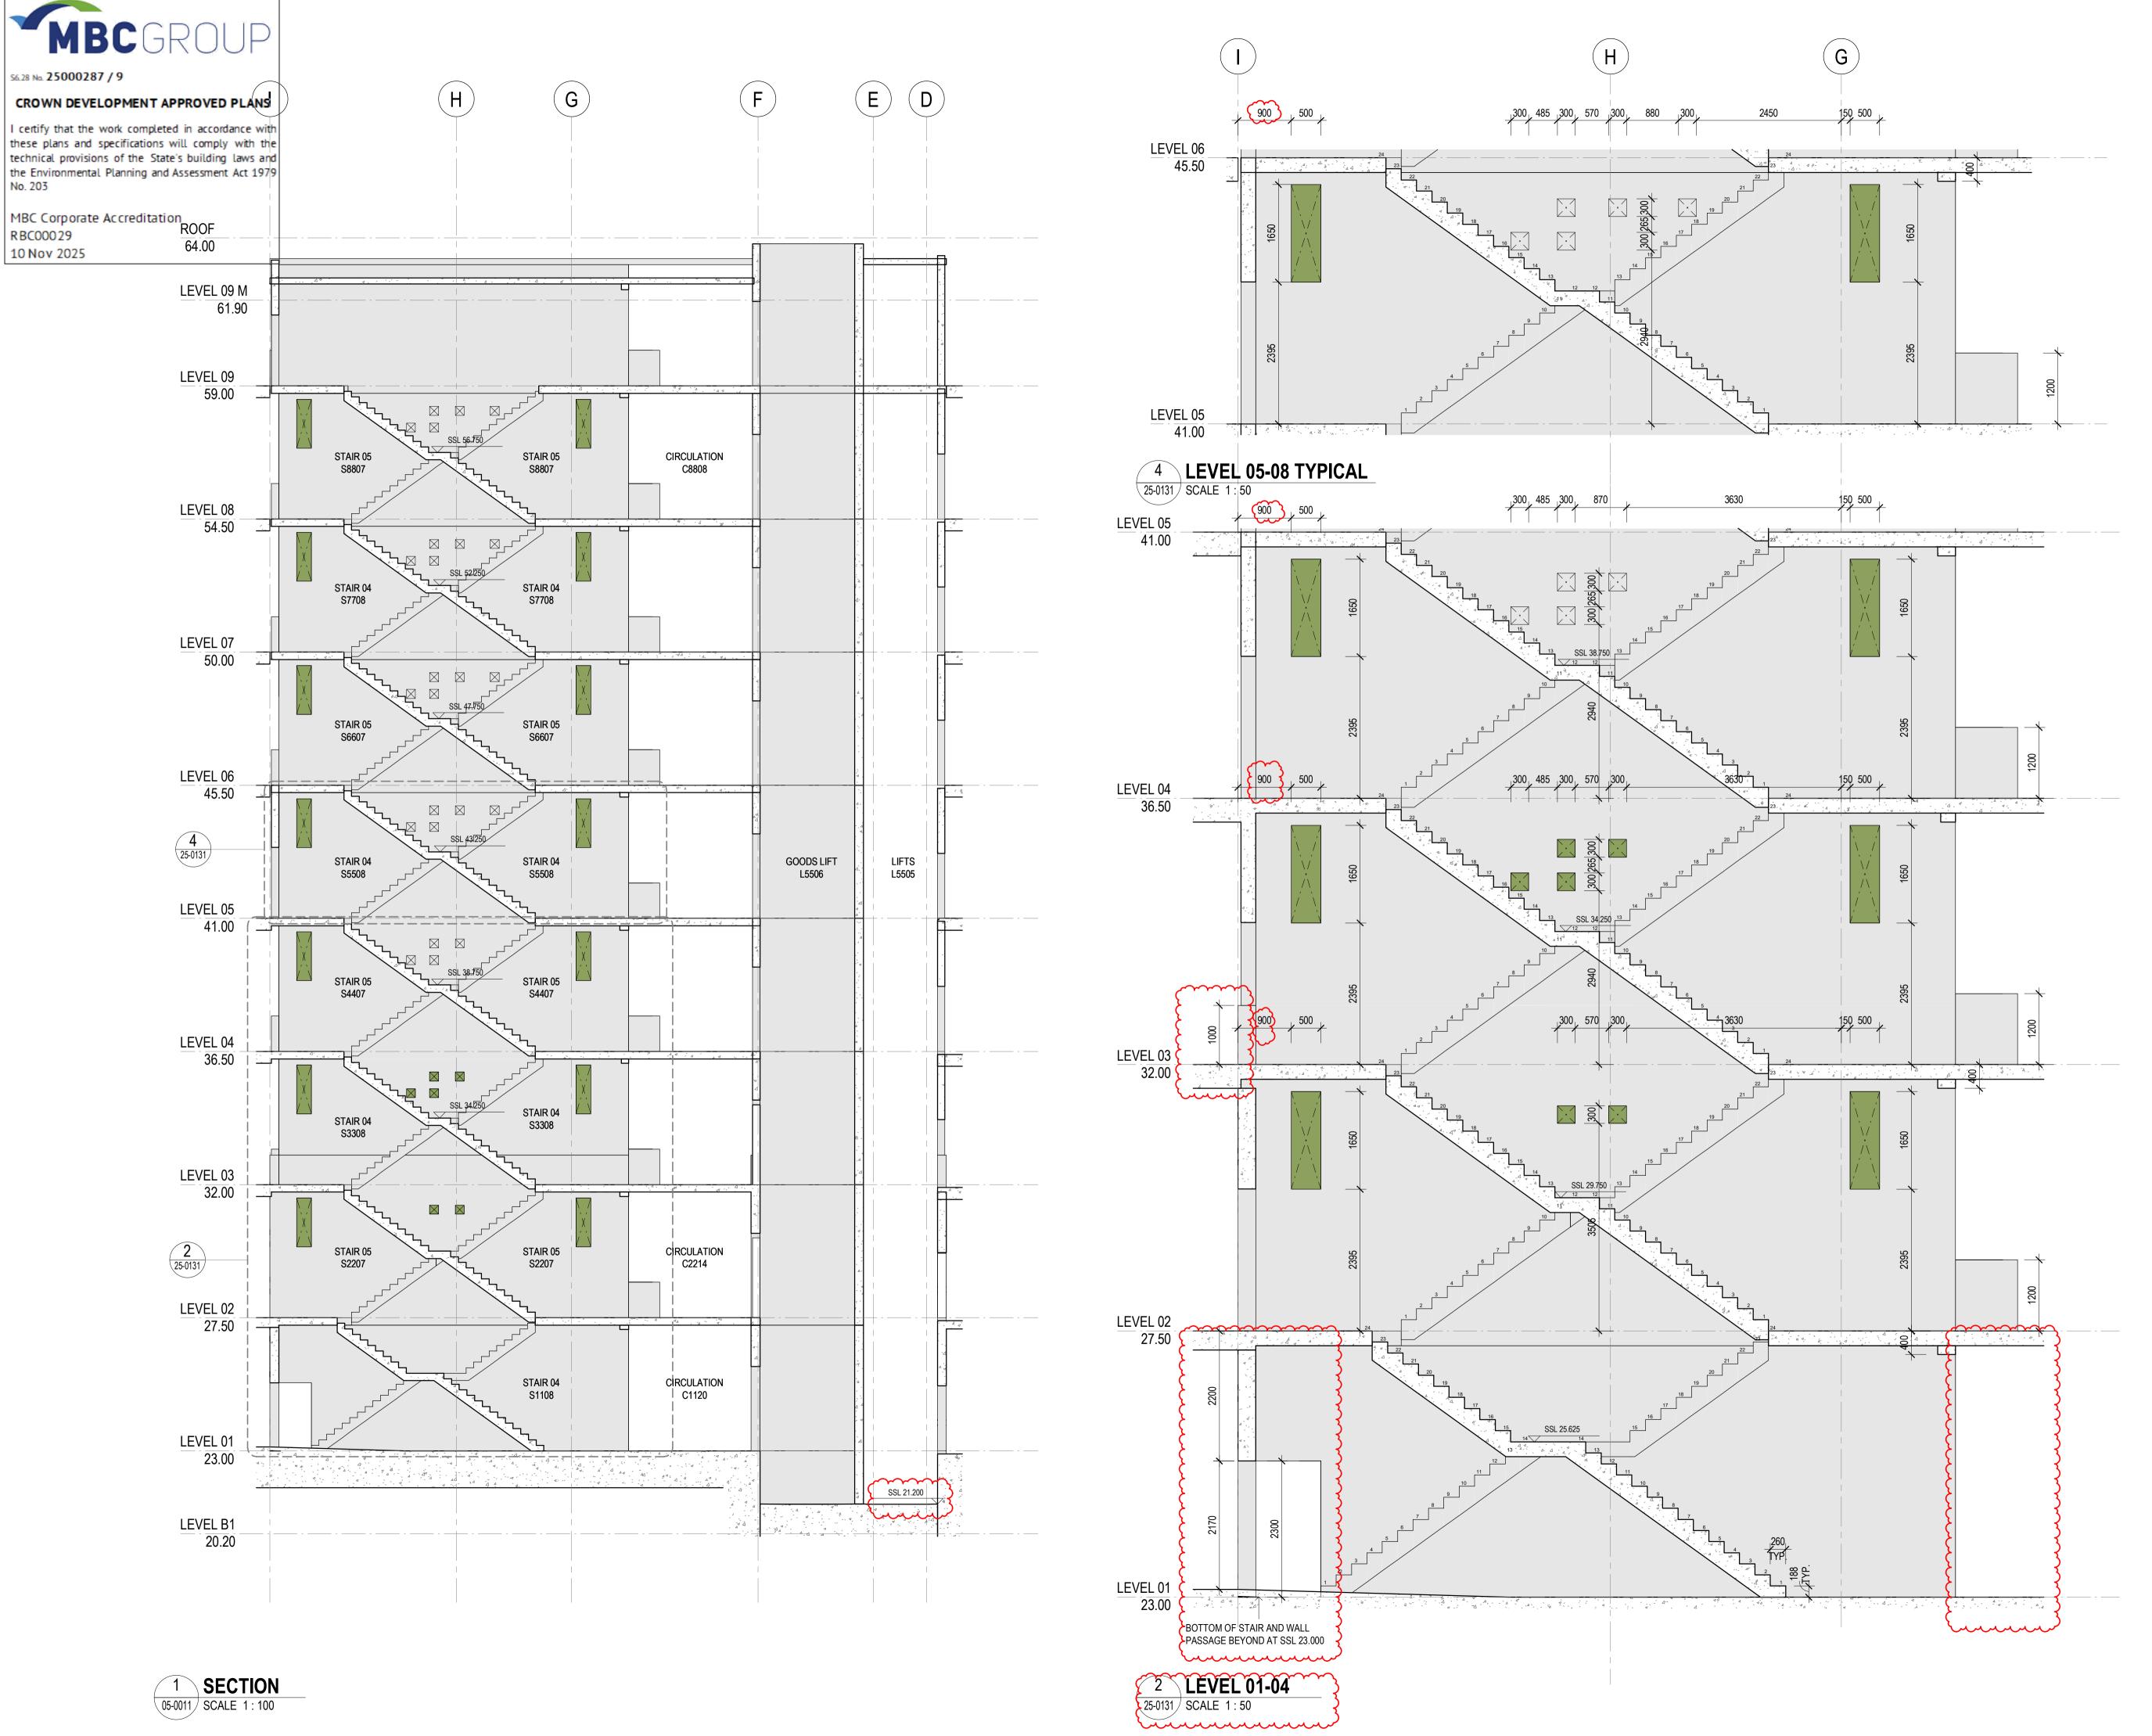
Drawing Status FOR COSTRUCTION

WESTERN CORE SETOUT ELEVATIONS -SHEET 10

GG

Project Number Drawing Number D0353 D19-A-X-25-0120

23/10/2025 2:09:49 PM 23/10/2025



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10 Nov 2025

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No. Date App Revision or reason for issue B 06/10/2025 WP IFC - CC2 C 23/10/2025 BG IFC - CC2

GENERAL NOTES

1. REFER LEGENDS AND GENERAL NOTES ON DRAWING A20_0000; A20_0010; A20_0020; A20_0100 2. TO BE READ IN CONJUNCTION WITH STRUCTURAL ENGINEER'S DOCUMENTATION FOR STRUCTURES SIZE

AND THICKNESS 3. PENETRATIONS SMALLER THAN 50MM DIA ARE OMITTED

LEGEND

FOUNDATION STRUCTURES. REFER TO A22 DRAWING SERIES FOR RAFT, PENETRATIONS THROUGH RAFT, AND LIFT PIT DETAILS

PENETRATION TYPE LEGEND

MECHANICAL SHAFT / PENETRATION ELECTRICAL/COMMS SHAFT / PENETRATION HYDRAULIC SHAFT / PENETRATION

FIRE SHAFT / PENETRATION

DRAWINGS STATUS:
- LEVEL 04-09 ARE NOT FOR CONSTRUCTION AS THEY ARE NOT PART OF CC2

SERVICES STRUCTURAL PENETRATIONS BASED OI - MECHANICAL SERVICES PENETRATIONS AS PER FRED AI



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Scale / North Point


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Drawing Status FOR CONSTRUCTION

WESTERN CORE SETOUT SECTIONS -SHEET 01

Project Number Drawing Number D0353 D19-A-X-25-0131 C

23/10/2025 3:53:18 PM 23/10/2025

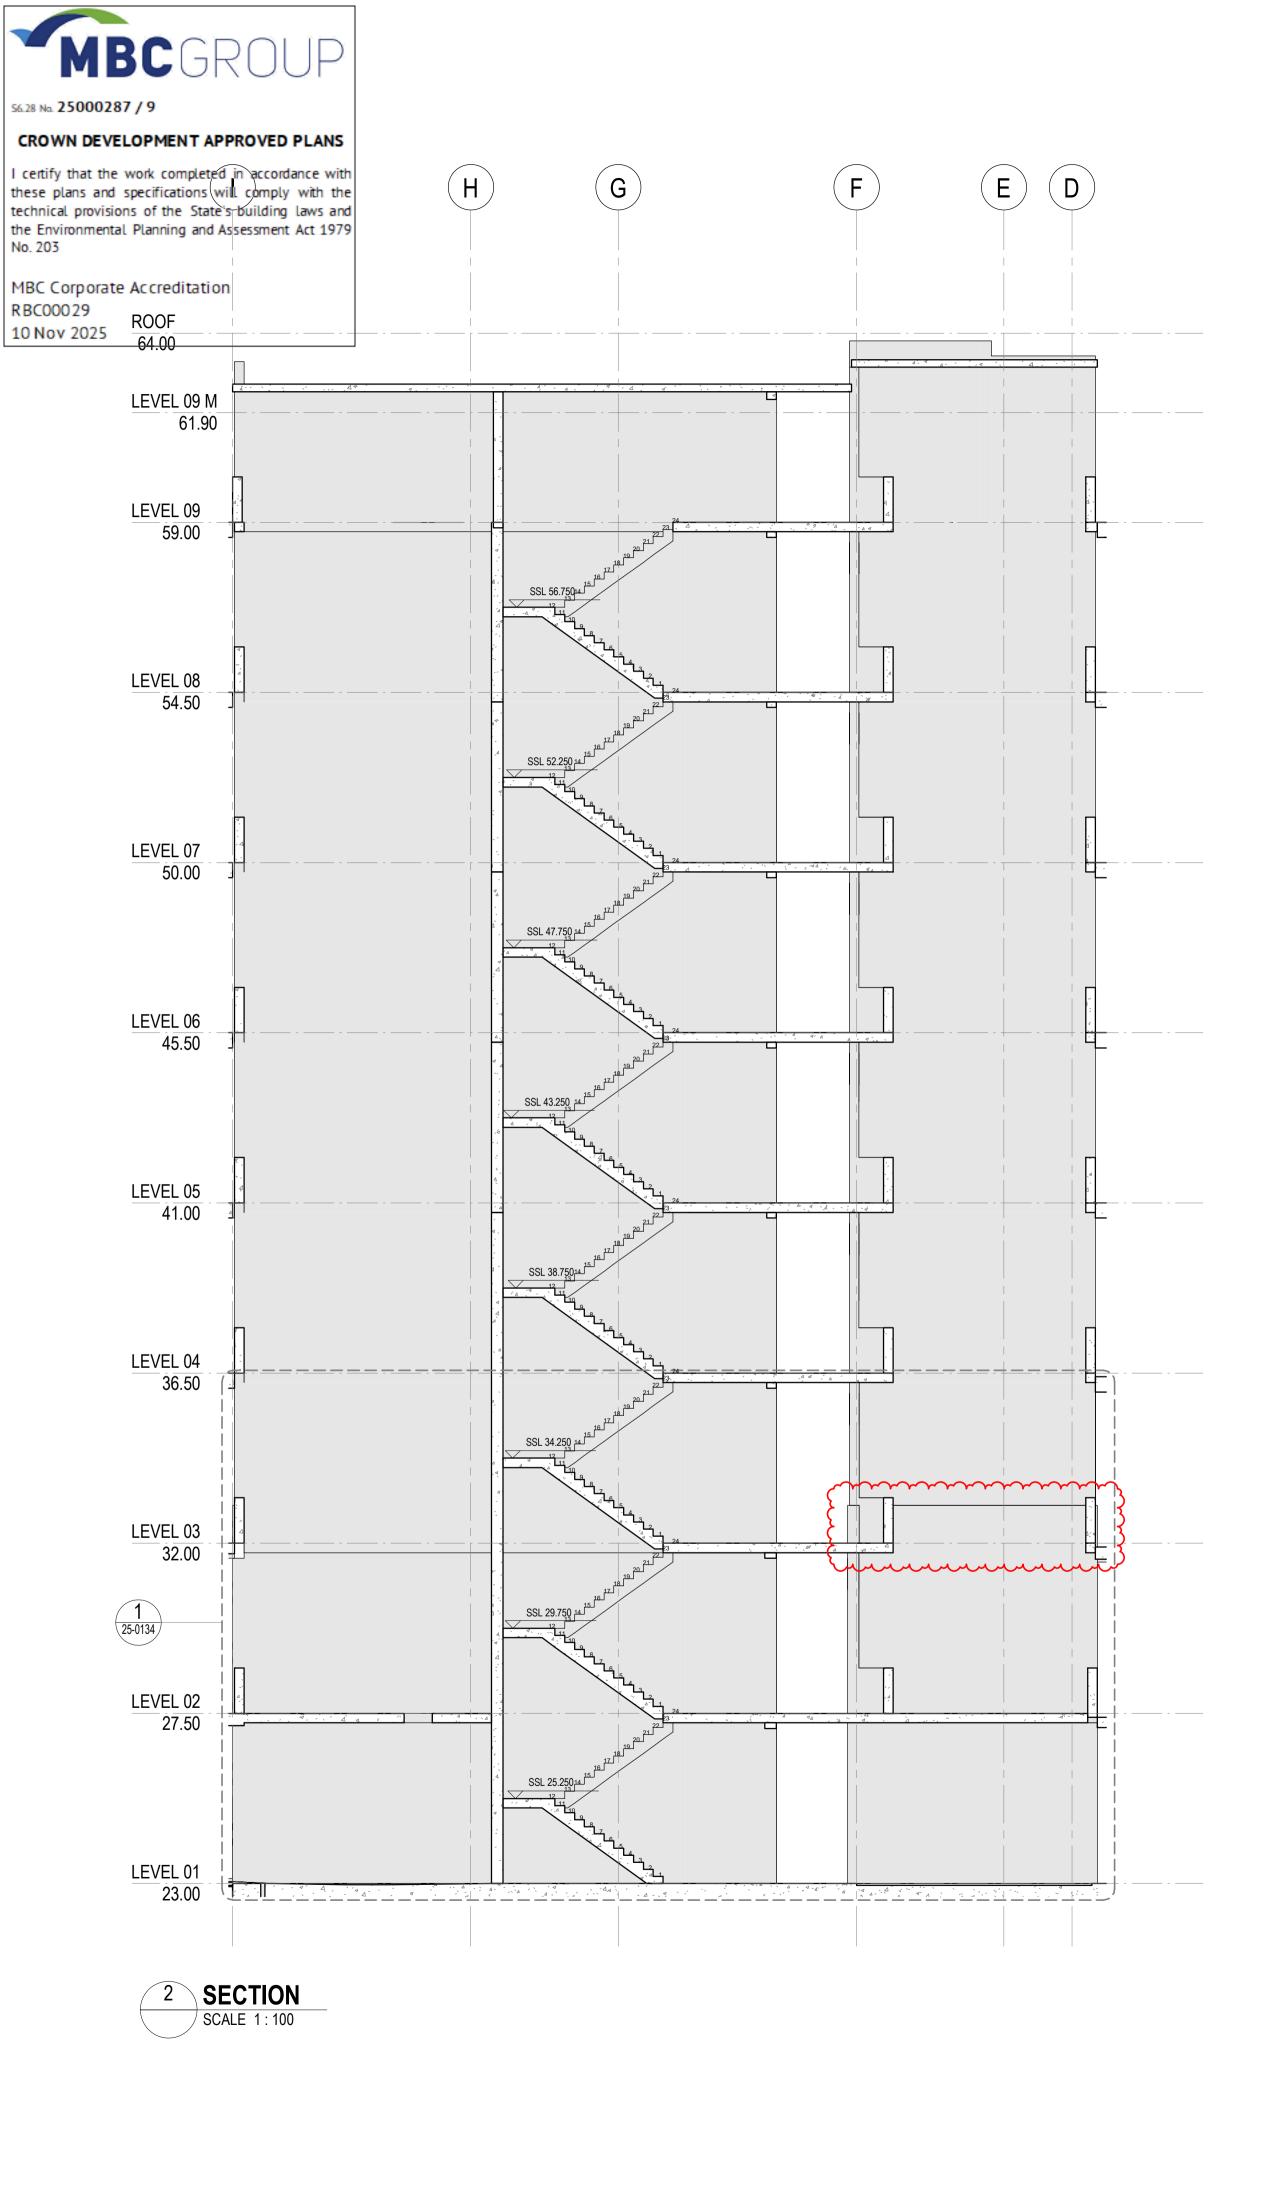

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No. Date App Revision or reason for issue B 06/10/2025 WP IFC - CC2 C 23/10/2025 BG IFC - CC2

GENERAL NOTES

1. REFER LEGENDS AND GENERAL NOTES ON DRAWING A20_0000; A20_0010; A20_0020; A20_0100 2. TO BE READ IN CONJUNCTION WITH STRUCTURAL ENGINEER'S DOCUMENTATION FOR STRUCTURES SIZE AND THICKNESS

3. PENETRATIONS SMALLER THAN 50MM DIA ARE OMITTED

LEGEND

FOUNDATION STRUCTURES. REFER TO A22 DRAWING SERIES FOR RAFT, PENETRATIONS THROUGH RAFT, AND LIFT PIT DETAILS

PENETRATION TYPE LEGEND

MECHANICAL SHAFT / PENETRATION ELECTRICAL/COMMS SHAFT / PENETRATION HYDRAULIC SHAFT / PENETRATION

FIRE SHAFT / PENETRATION

DRAWINGS STATUS:
- LEVEL 04-09 ARE NOT FOR CONSTRUCTION AS THEY ARE NOT PART OF CC2



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Scale / North Point 1:50 @ A1 0 0.5 1 1.5 2.5M 1:100 @ A3

Drawing Status FOR COSTRUCTION

WESTERN CORE SETOUT SECTIONS -SHEET 03

GG CG

Project Number Drawing Number D0353


D19-A-X-25-0133 C

23/10/2025 2:10:26 PM 23/10/2025

CROWN DEVELOPMENT APPROVED PLANS

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General Notes

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No. Date App Revision or reason for issue B 06/10/2025 WP IFC - CC2 C 23/10/2025 BG IFC - CC2

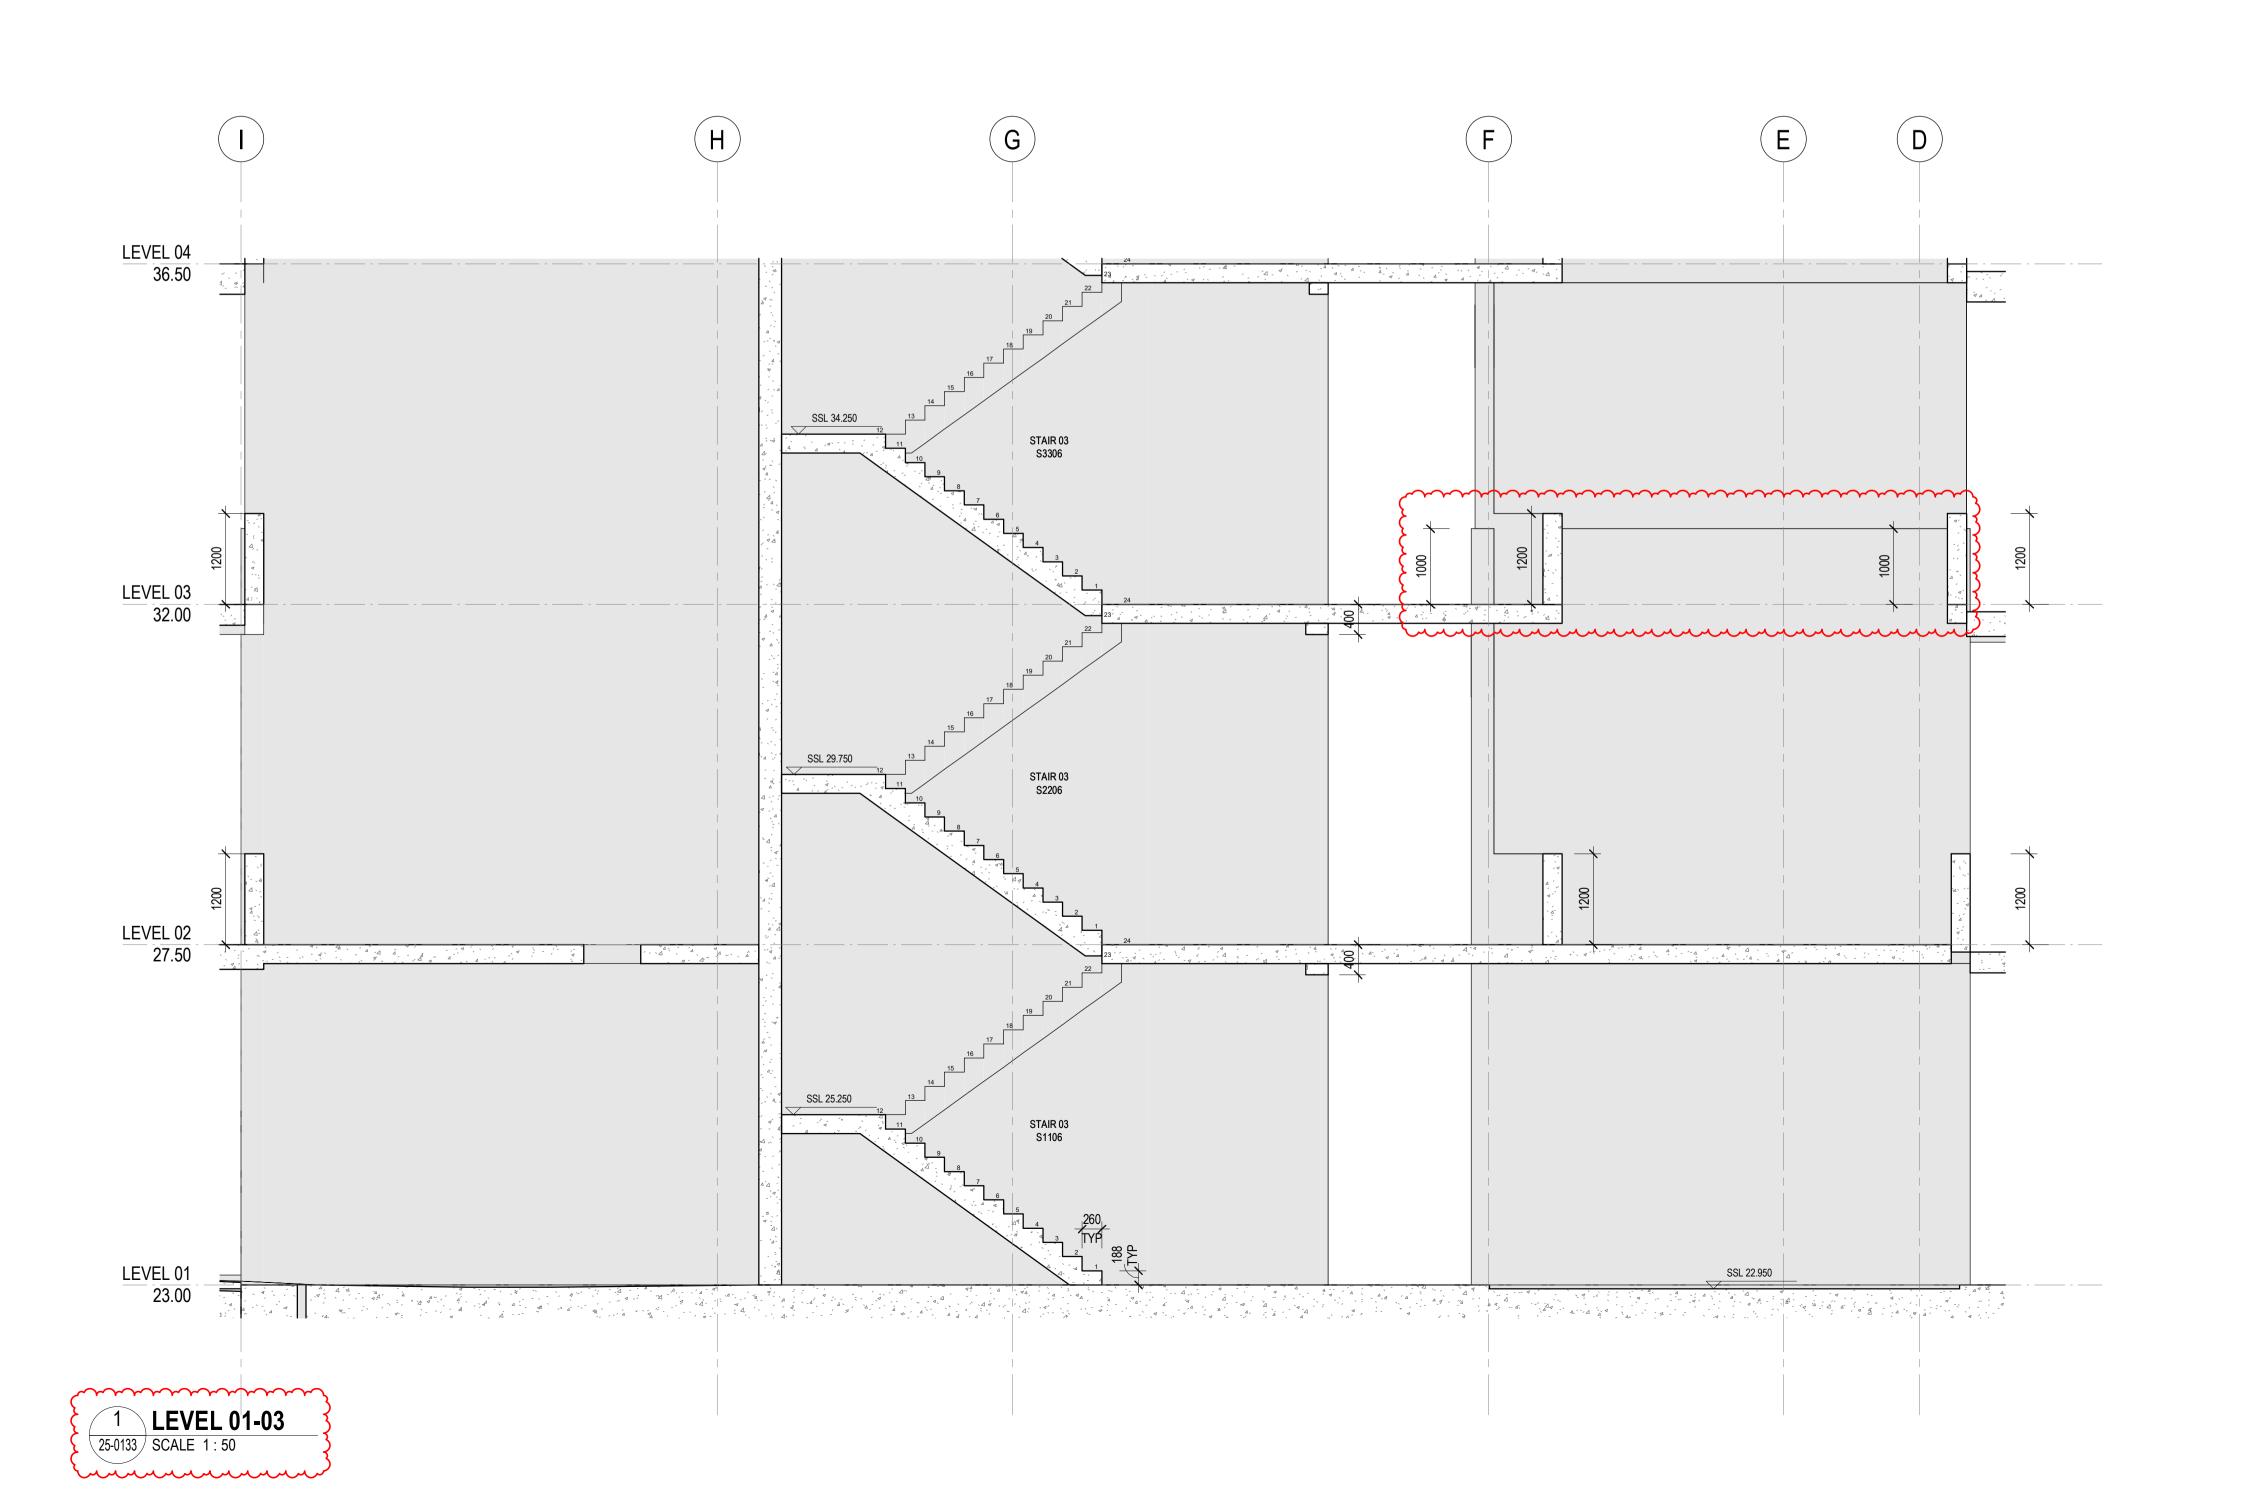GENERAL NOTES

1. REFER LEGENDS AND GENERAL NOTES ON DRAWING A20_0000; A20_0010; A20_0020; A20_0100 2. TO BE READ IN CONJUNCTION WITH STRUCTURAL ENGINEER'S DOCUMENTATION FOR STRUCTURES SIZE AND THICKNESS

3. PENETRATIONS SMALLER THAN 50MM DIA ARE OMITTED

LEGEND

FOUNDATION STRUCTURES. REFER TO A22 DRAWING SERIES FOR RAFT, PENETRATIONS THROUGH RAFT, AND LIFT PIT DETAILS

PENETRATION TYPE LEGEND

MECHANICAL SHAFT / PENETRATION ELECTRICAL/COMMS SHAFT / PENETRATION HYDRAULIC SHAFT / PENETRATION

FIRE SHAFT / PENETRATION

DRAWINGS STATUS:
- LEVEL 04-09 ARE NOT FOR CONSTRUCTION AS THEY ARE NOT PART OF CC2 SECURITY SERVICES PENETRATIONS NOT INCLUDED

- STRUCTURAL DOOR OPENINGS AS PER RCC-GCOR-003669



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Scale / North	Point				
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Drawing Status FOR COSTRUCTION

WESTERN CORE SETOUT SECTIONS -SHEET 04

Project Number Drawing Number D0353

D19-A-X-25-0134 C


23/10/2025 2:07:50 PM 23/10/2025

CROWN DEVELOPMENT APPROVED PLANS

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App Revision or reason for issue B 06/10/2025 WP IFC - CC2 C 22/10/2025 BG IFC - CC2

GENERAL NOTES

1. REFER LEGENDS AND GENERAL NOTES ON DRAWING A20 0000; A20 0010; A20 0020; A20 0100 2. TO BE READ IN CONJUNCTION WITH STRUCTURAL ENGINEER'S DOCUMENTATION FOR STRUCTURES SIZE

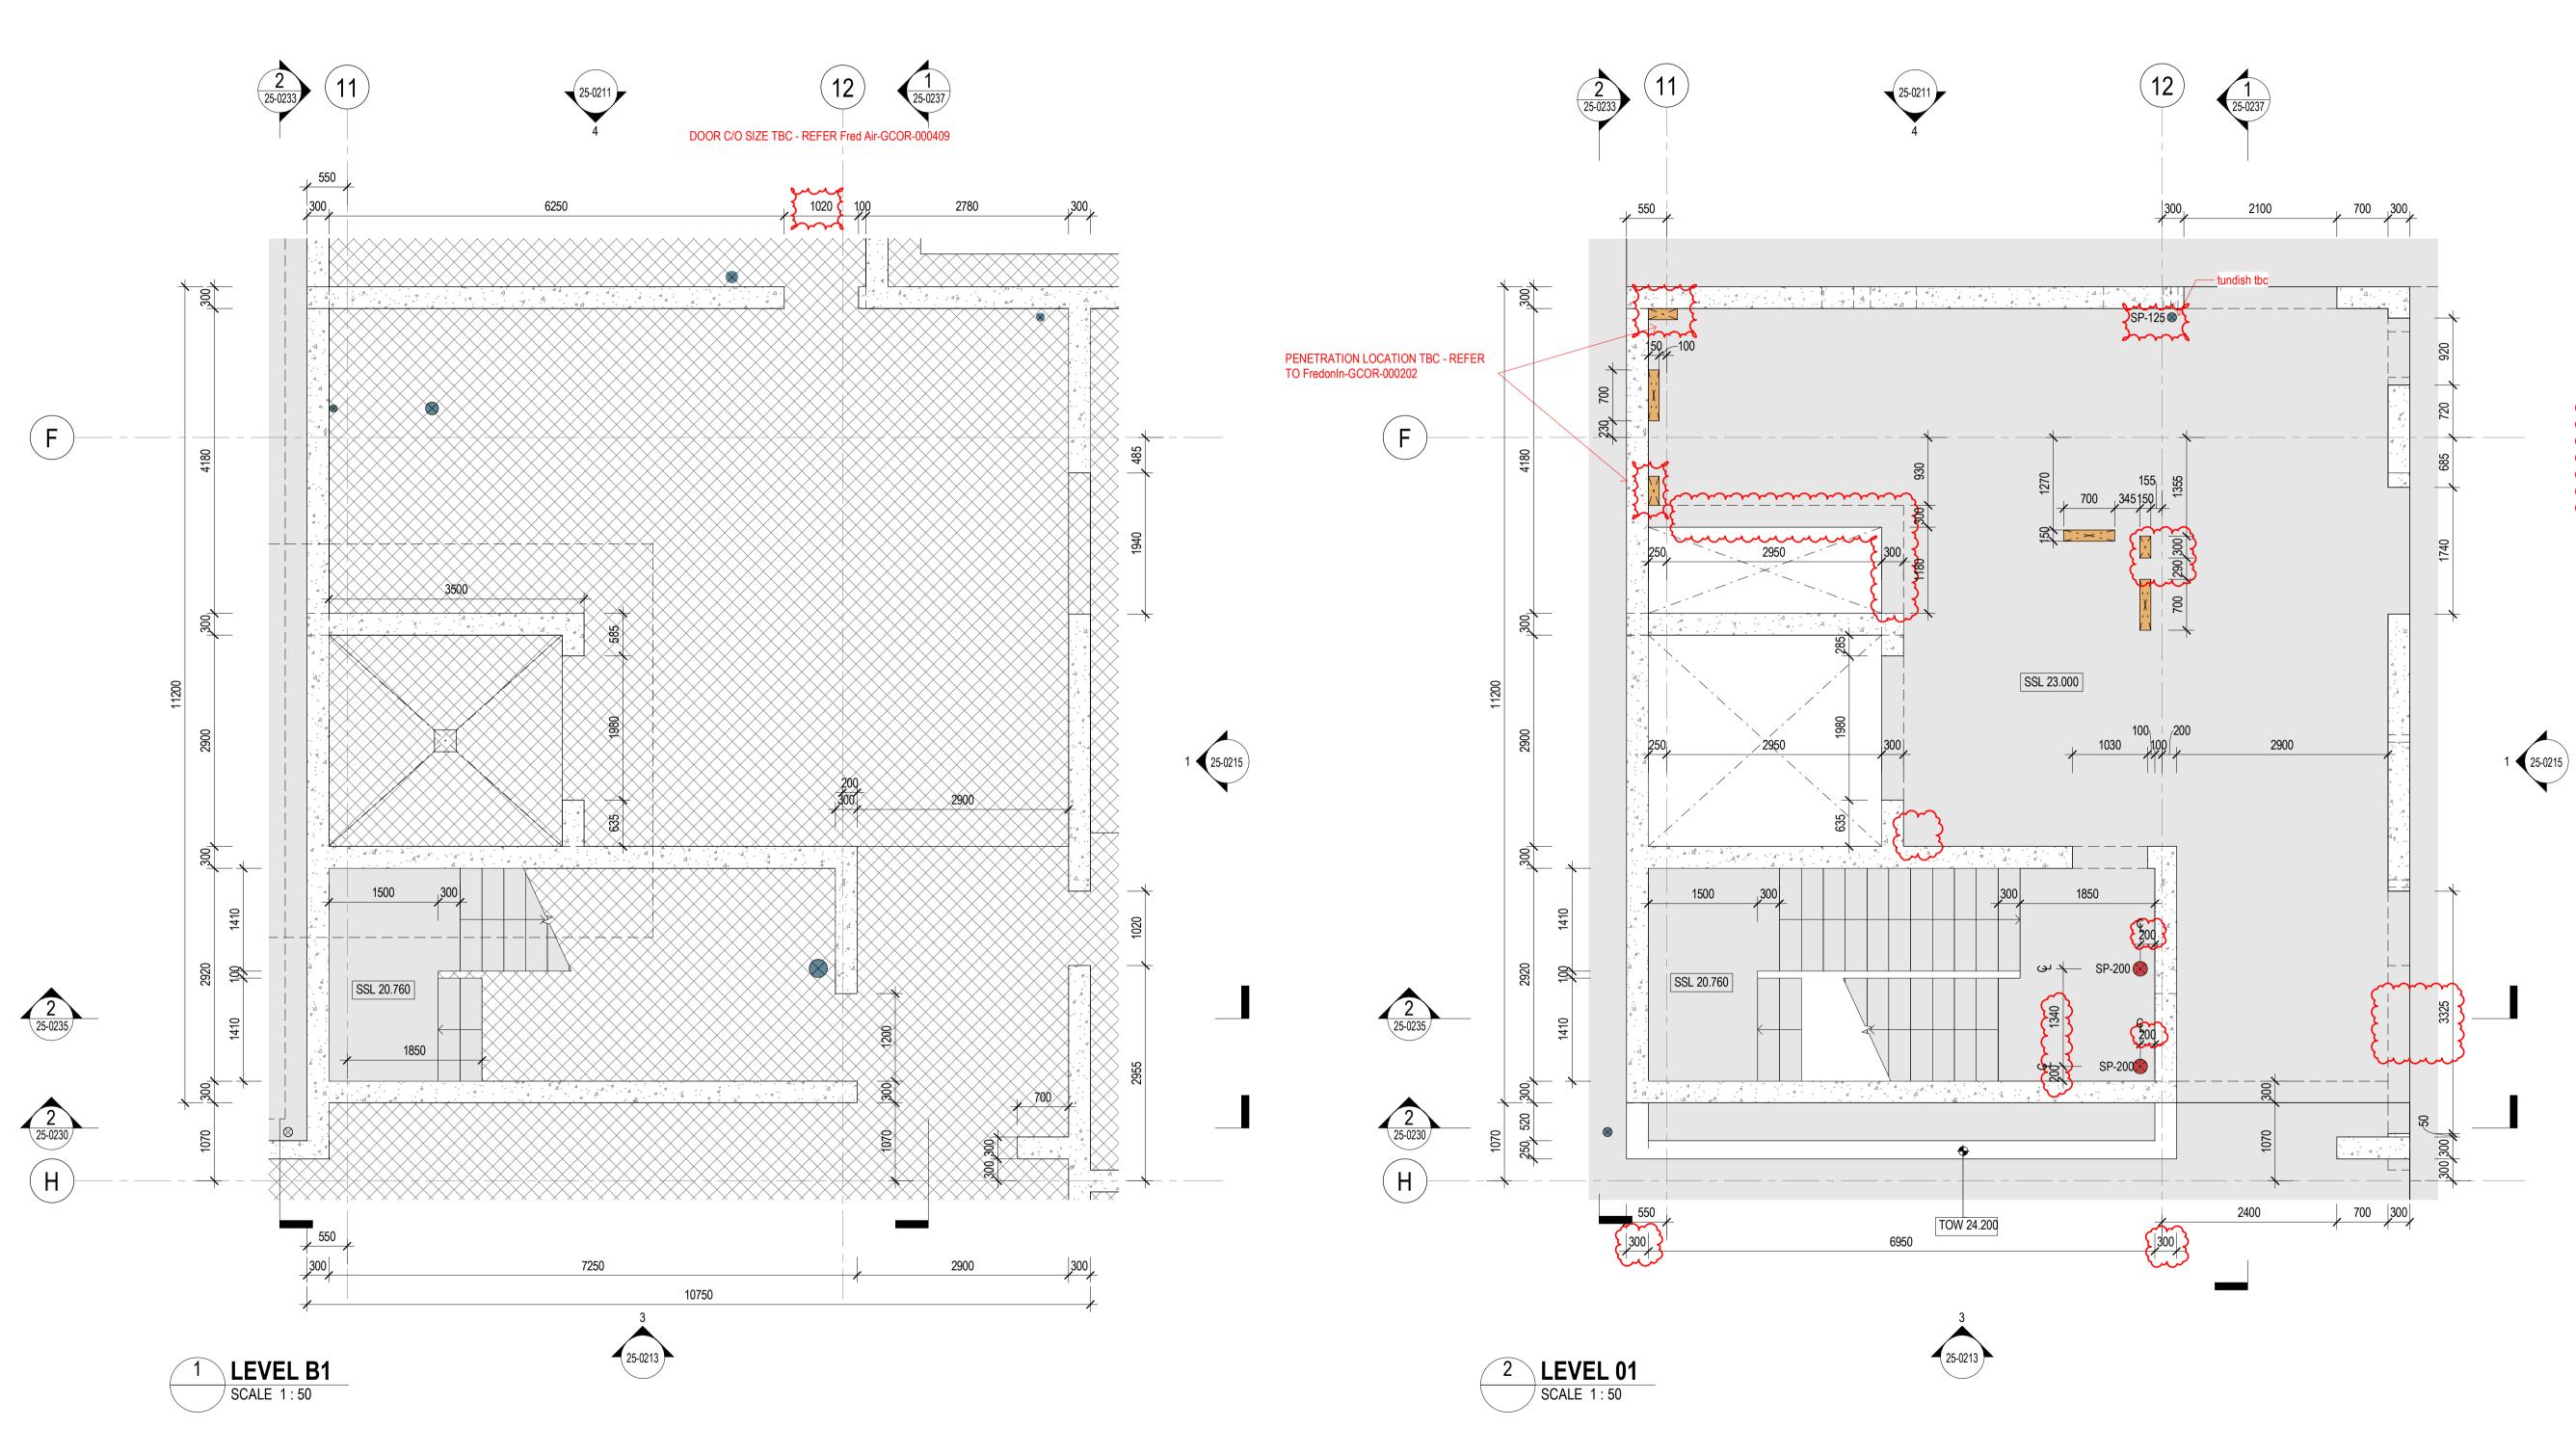AND THICKNESS 3. PENETRATIONS SMALLER THAN 50MM DIA ARE OMITTED

LEGEND

FOUNDATION STRUCTURES. REFER TO A22 DRAWING SERIES FOR RAFT, PENETRATIONS THROUGH RAFT, AND LIFT PIT DETAILS

PENETRATION TYPE LEGEND

MECHANICAL SHAFT / PENETRATION ELECTRICAL/COMMS SHAFT / PENETRATION

HYDRAULIC SHAFT / PENETRATION FIRE SHAFT / PENETRATION

<u>DRAWINGS STATUS:</u>
- LEVEL 04-09 ARE NOT FOR CONSTRUCTION AS THEY ARE NOT PART OF CC2 - SECURITY SERVICES PENETRATIONS NOT INCLUDED

(- STRUCTURAL DOOR OPENINGS AS PER RCC-GCOR-003669)

SERVICES STRUCTURAL PENETRATIONS BASED ON: - FIRE SERVICES PENETRATIONS AS PER EMERGEFP-GCOR-000041, EMERGEFP-GCOR-000043, EmergeFP-GCOR-000074 - HYDRAULIC SERVICES PENETRATIONS AS PER HYDRAULIC SERVICES

MODEL, ACORCONS-GCOR-000048, RCC-GCOR-003665 - ELECTRICAL SERVICES PENETRATIONS AS PER Fredonin-GCOR-000127 RCC-GCOR-003665, DCM-GCOR-000731, RCC-GCOR-003665, FredonIn-- STRUCTURES AS PER RCC-GCOR-002926, MMcD-GCOR-000422, RCC-GCOB-003665 COLOR COLOR



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Scale / North Point									
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Drawing Status FOR CONSTRUCTION

CENTRAL CORE SETOUT PLANS - SHEET

CG

Project Number D0353

GG

Drawing Number D19-A-X-25-0201 C


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CROWN DEVELOPMENT APPROVED PLANS

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10 Nov 2025



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App Revision or reason for issue B 06/10/2025 WP IFC - CC2 C 22/10/2025 BG IFC - CC2

GENERAL NOTES

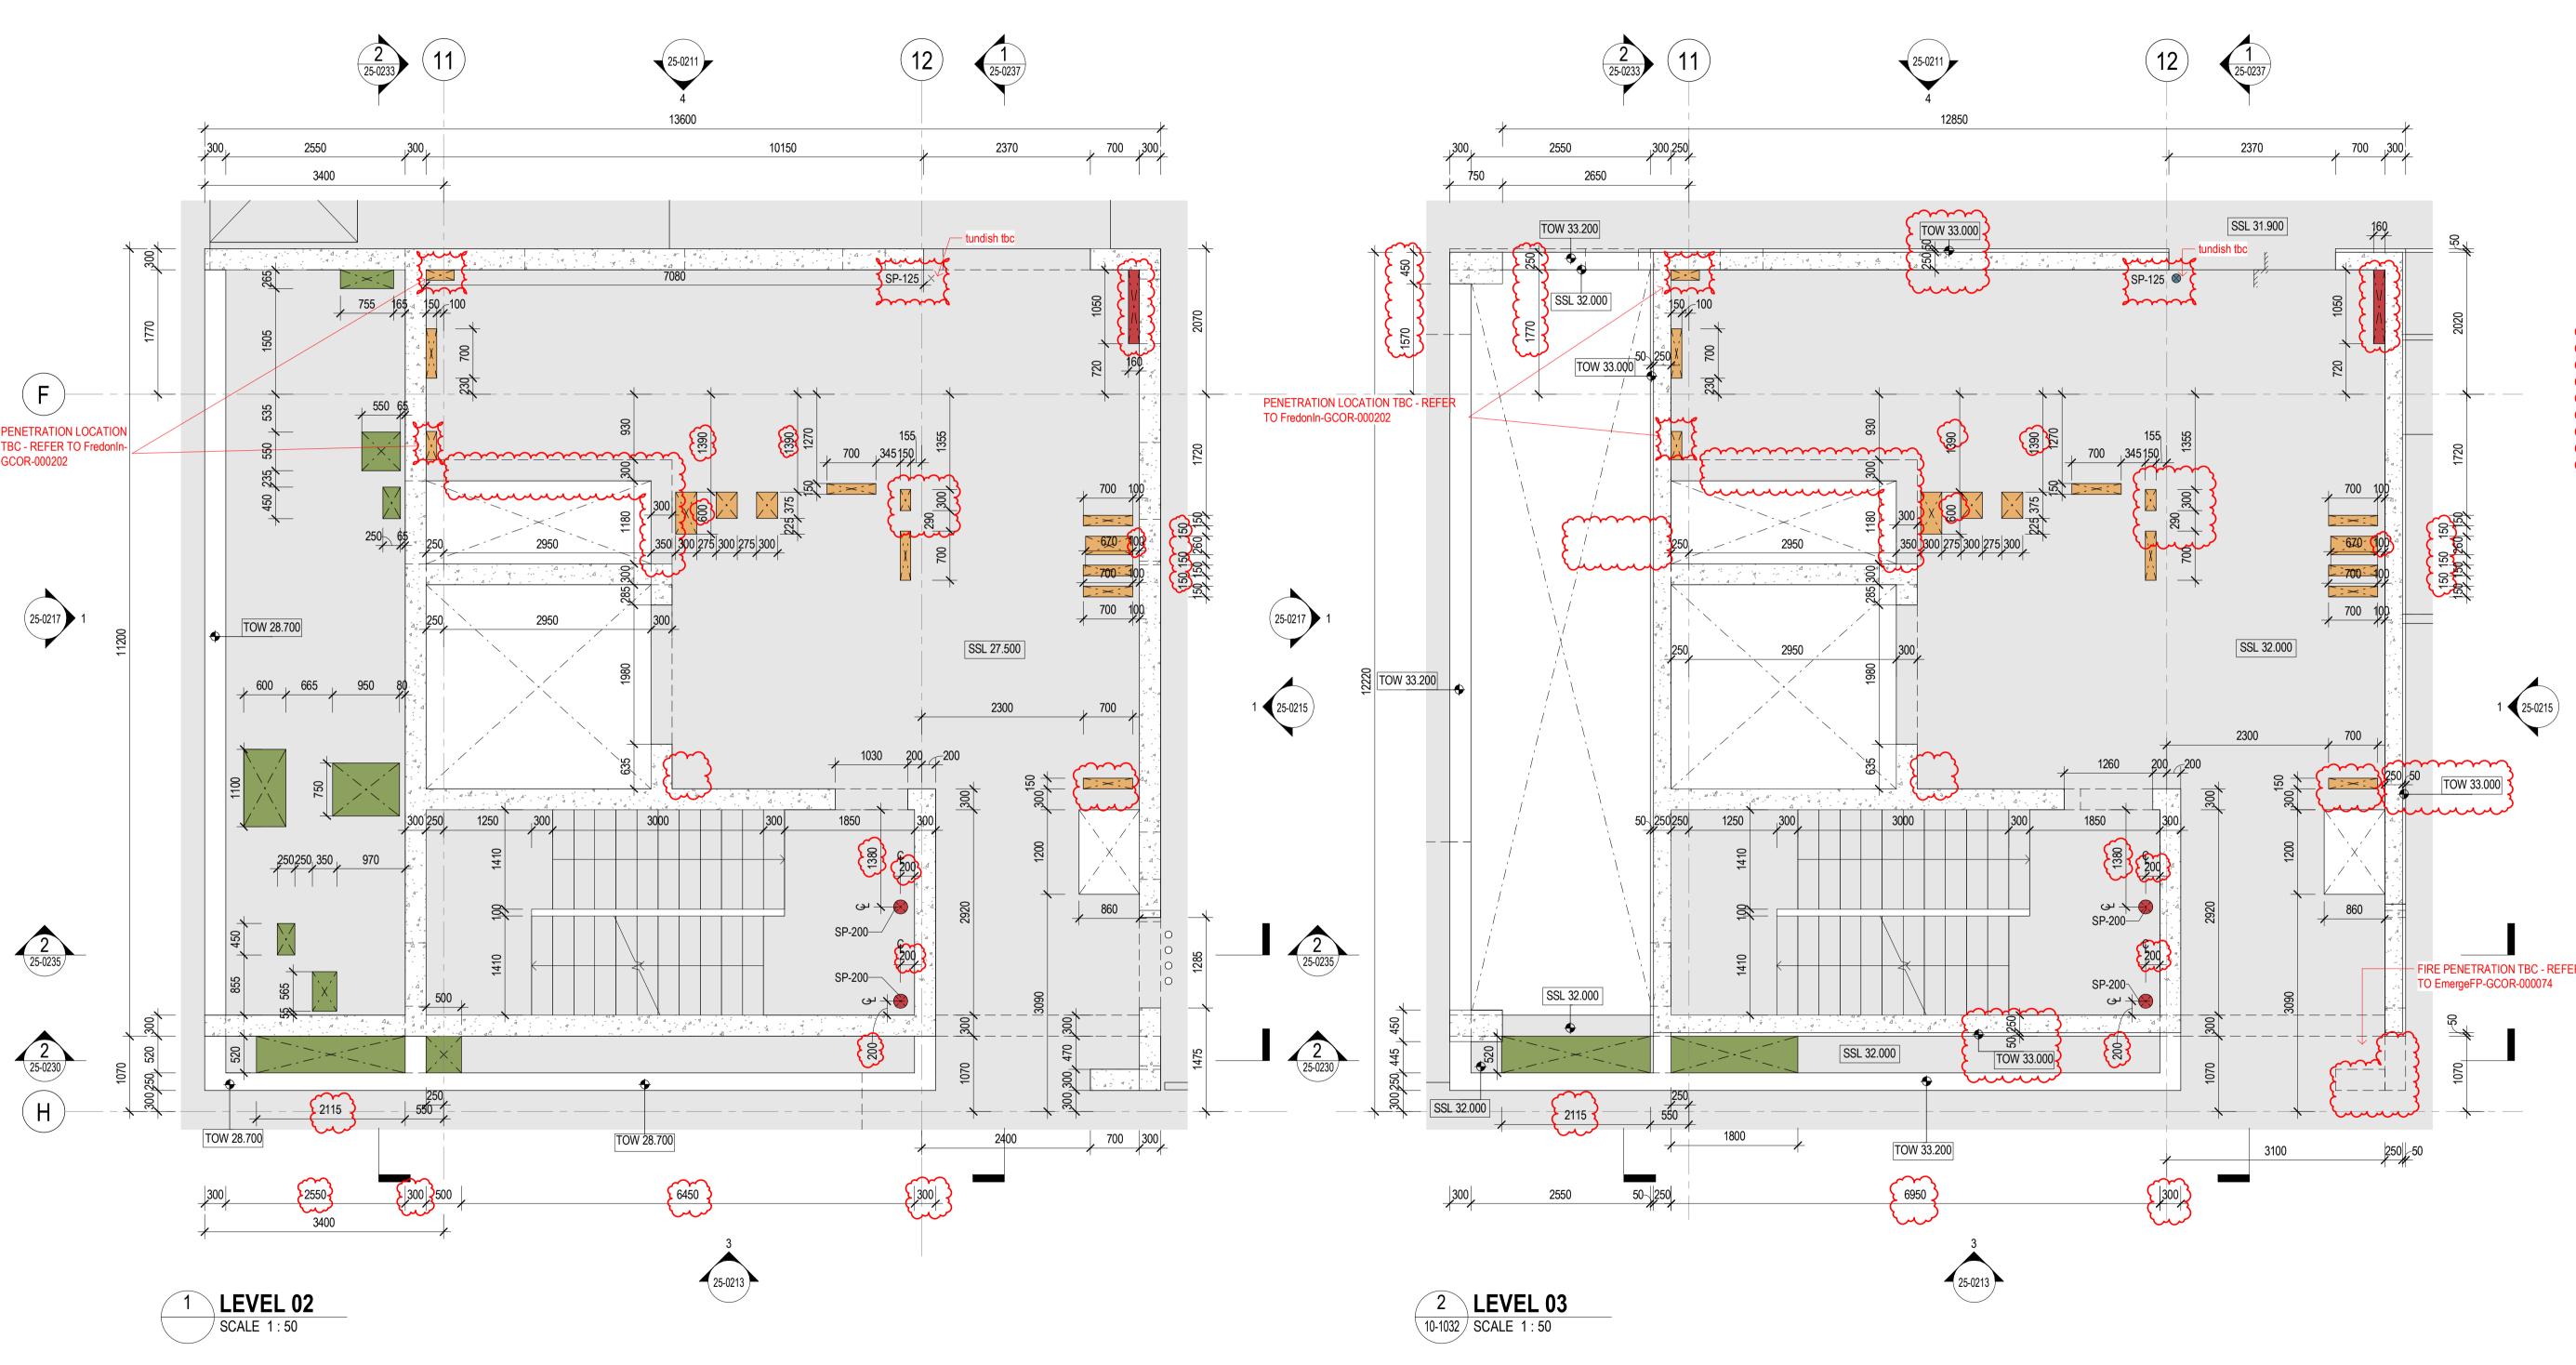1. REFER LEGENDS AND GENERAL NOTES ON DRAWING A20_0000; A20_0010; A20_0020; A20_0100 2. TO BE READ IN CONJUNCTION WITH STRUCTURAL ENGINEER'S DOCUMENTATION FOR STRUCTURES SIZE AND THICKNESS

3. PENETRATIONS SMALLER THAN 50MM DIA ARE OMITTED

LEGEND

FOUNDATION STRUCTURES. REFER TO A22 DRAWING SERIES FOR RAFT, PENETRATIONS THROUGH RAFT, AND LIFT PIT DETAILS

PENETRATION TYPE LEGEND

MECHANICAL SHAFT / PENETRATION ELECTRICAL/COMMS SHAFT / PENETRATION HYDRAULIC SHAFT / PENETRATION

FIRE SHAFT / PENETRATION

DRAWINGS STATUS: - LEVEL 04-09 ARE NOT FOR CONSTRUCTION AS THEY ARE

NOT PART OF CC2

SERVICES STRUCTURAL PENETRATIONS BASED ON:

- FIRE SERVICES PENETRATIONS AS PER EMERGEFP-GCOR-000041, EMERGEFP-GCOR-000043, EmergeFP-GCOR-000074 - HYDRAULIC SERVICES PENETRATIONS AS PER HYDRAULIC SERVICES MODEL, ACORCONS-GCOR-000048, RCC-GCOR-003665 - MECHANICAL AND GAS SERVICES PENETRATIONS AS PER FRED AIR-GCOR-000300, Hoslab-GCOR-000098, RCC-GCOR-003665, Fred Air-- ELECTRICAL SERVICES PENETRATIONS AS PER FredonIn-GCOR-000127,

RCC-GCOR-003665, FredonIn-GCOR-000197 - STRUCTURES AS PER RCC-GCOR-002926, MMcD-GCOR-000422, RCC-



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Scale / North Point

Drawing Status FOR CONSTRUCTION

CENTRAL CORE SETOUT PLANS - SHEET


GG CG


Project Number

D0353

Drawing Number

D19-A-X-25-0202 22/10/2025 6:02:10 PM 22/10/2025

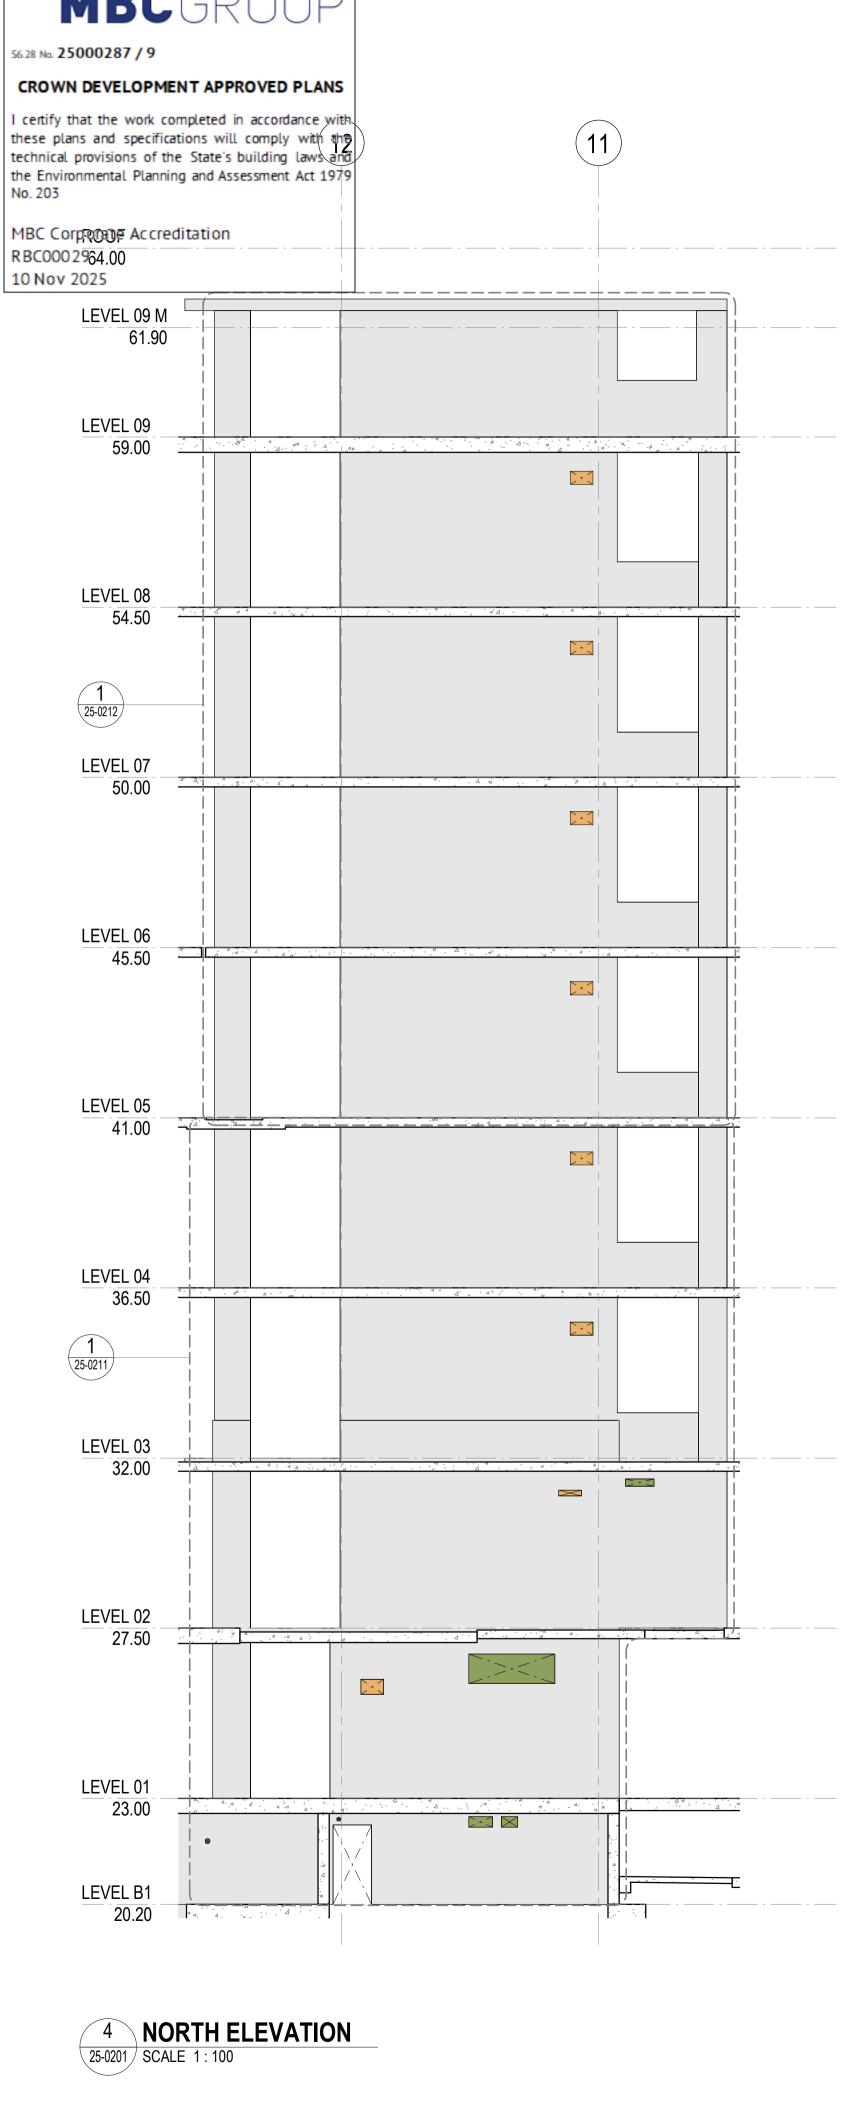

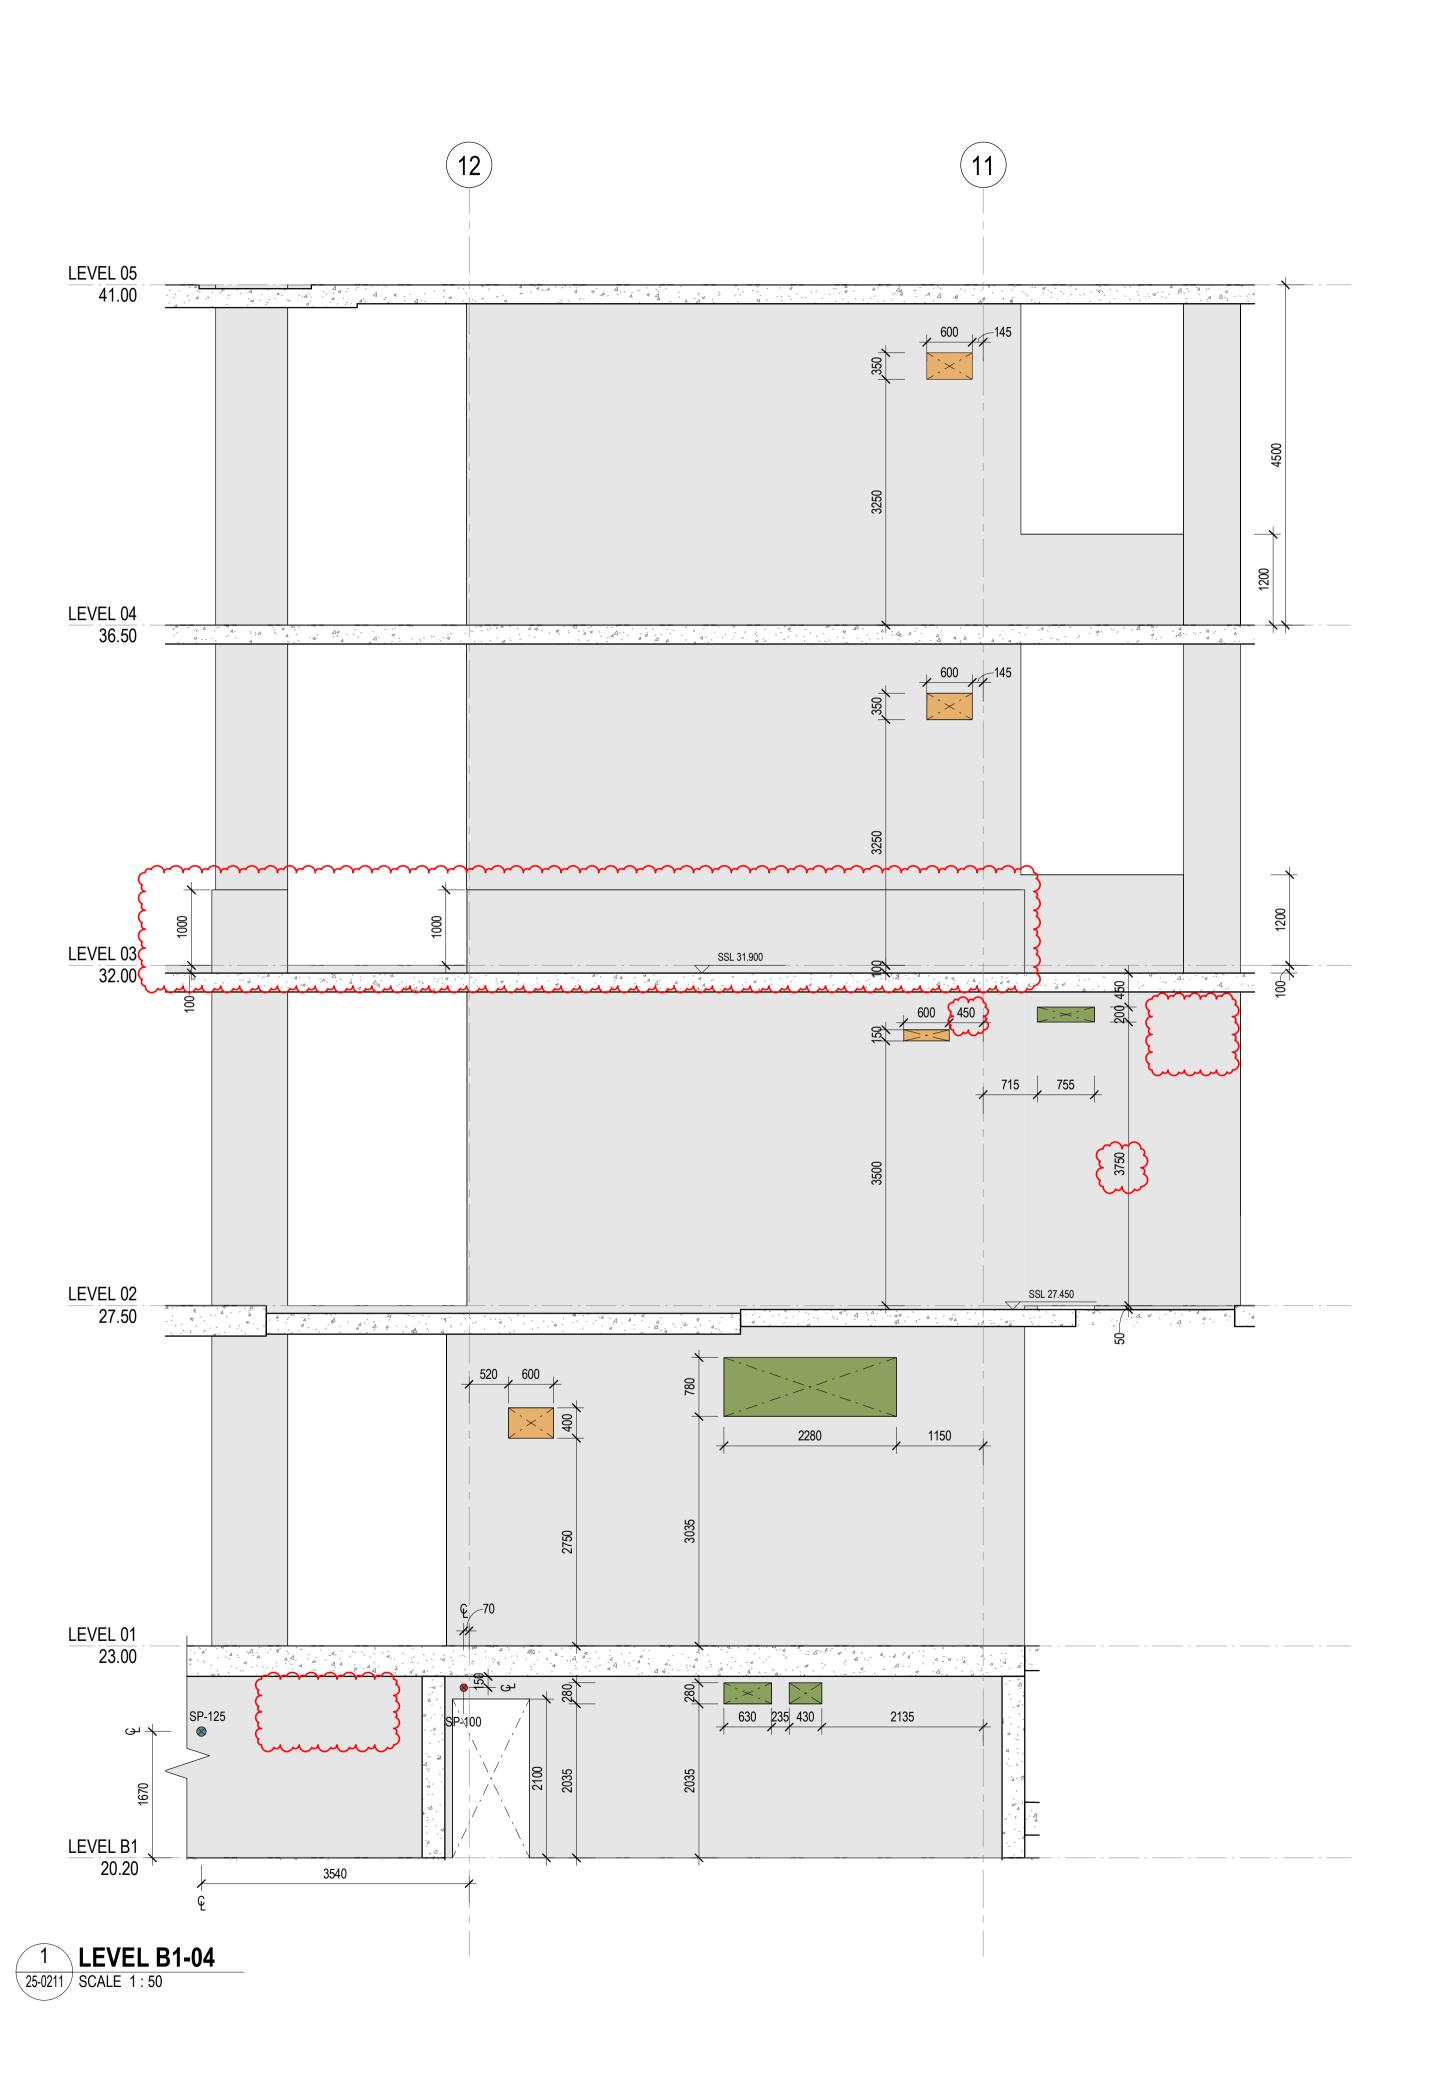

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 No.
 Date
 App
 Revision or reason for issue

 B
 06/10/2025
 WP
 IFC - CC2

 C
 21/10/2025
 BG
 IFC - CC2

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2. TO BE READ IN CONJUNCTION WITH STRUCTURAL ENGINEER'S DOCUMENTATION FOR STRUCTURES SIZE AND THICKNESS

3. PENETRATIONS SMALLER THAN 50MM DIA ARE OMITTED

LEGEND

FOUNDATION STRUCTURES. REFER TO A22
DRAWING SERIES FOR RAFT, PENETRATIONS
THROUGH RAFT, AND LIFT PIT DETAILS

PENETRATION TYPE LEGEND

MECHANICAL SHAFT / PENETRATION
ELECTRICAL/COMMS SHAFT / PENETRATION
HYDRAULIC SHAFT / PENETRATION

FIRE SHAFT / PENETRATION

DRAWINGS STATUS: - LEVEL 04-09 ARE NOT FOR CONSTRUCTION AS THEY ARE

NOT PART OF CC2

-SECURITY SERVICES PENETRATIONS NOT INCLUDED

- STRUCTURAL DOOR OPENINGS AS PER RCC-GCOR-003669

SERVICES STRUCTURAL PENETRATIONS BASED ON:

- FIRE SERVICES PENETRATIONS AS PER FIRE SERVICES MODEL,
EMERGEFP-GCOR-000041, EMERGEFP-GCOR-000043

- HYDRAULIC SERVICES PENETRATIONS AS PER HYDRAULIC SERVICES
MODEL, ACORCONS-GCOR-000048, RCC-GCOR-003665

- MECHANICAL SERVICES PENETRATIONS AS PER FRED AIRGCOR-000300, Hoslab-GCOR-000098, RCC-GCOR-003665, MMcDRTRFI-000045, Fred Air-GCOR-000379, Fred Air-GCOR-000425

- ELECTRICAL SERVICES PENETRATIONS AS PER RCC-GCOR-003665,
DCM-GCOR-000831

- STRUCTURES AS PER RCC-GCOR-002926, MMcD-GCOR-000422



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Drawing Status FOR CONSTRUCTION

Drawing Title
CENTRAL CORE SETOUT ELEVATIONS SHEET 01

Project Number **D0353**

GG

Drawing Number Revision
D19-A-X-25-0211
C

Print Date Issue Date 22/10/2025 6:02:19 PM 21/10/2025


CROWN DEVELOPMENT APPROVED PLANS

S6.28 No. 25000287 / 9

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AND THICKNESS 3. PENETRATIONS SMALLER THAN 50MM DIA ARE OMITTED

LEGEND

FOUNDATION STRUCTURES. REFER TO A22 DRAWING SERIES FOR RAFT, PENETRATIONS THROUGH RAFT, AND LIFT PIT DETAILS

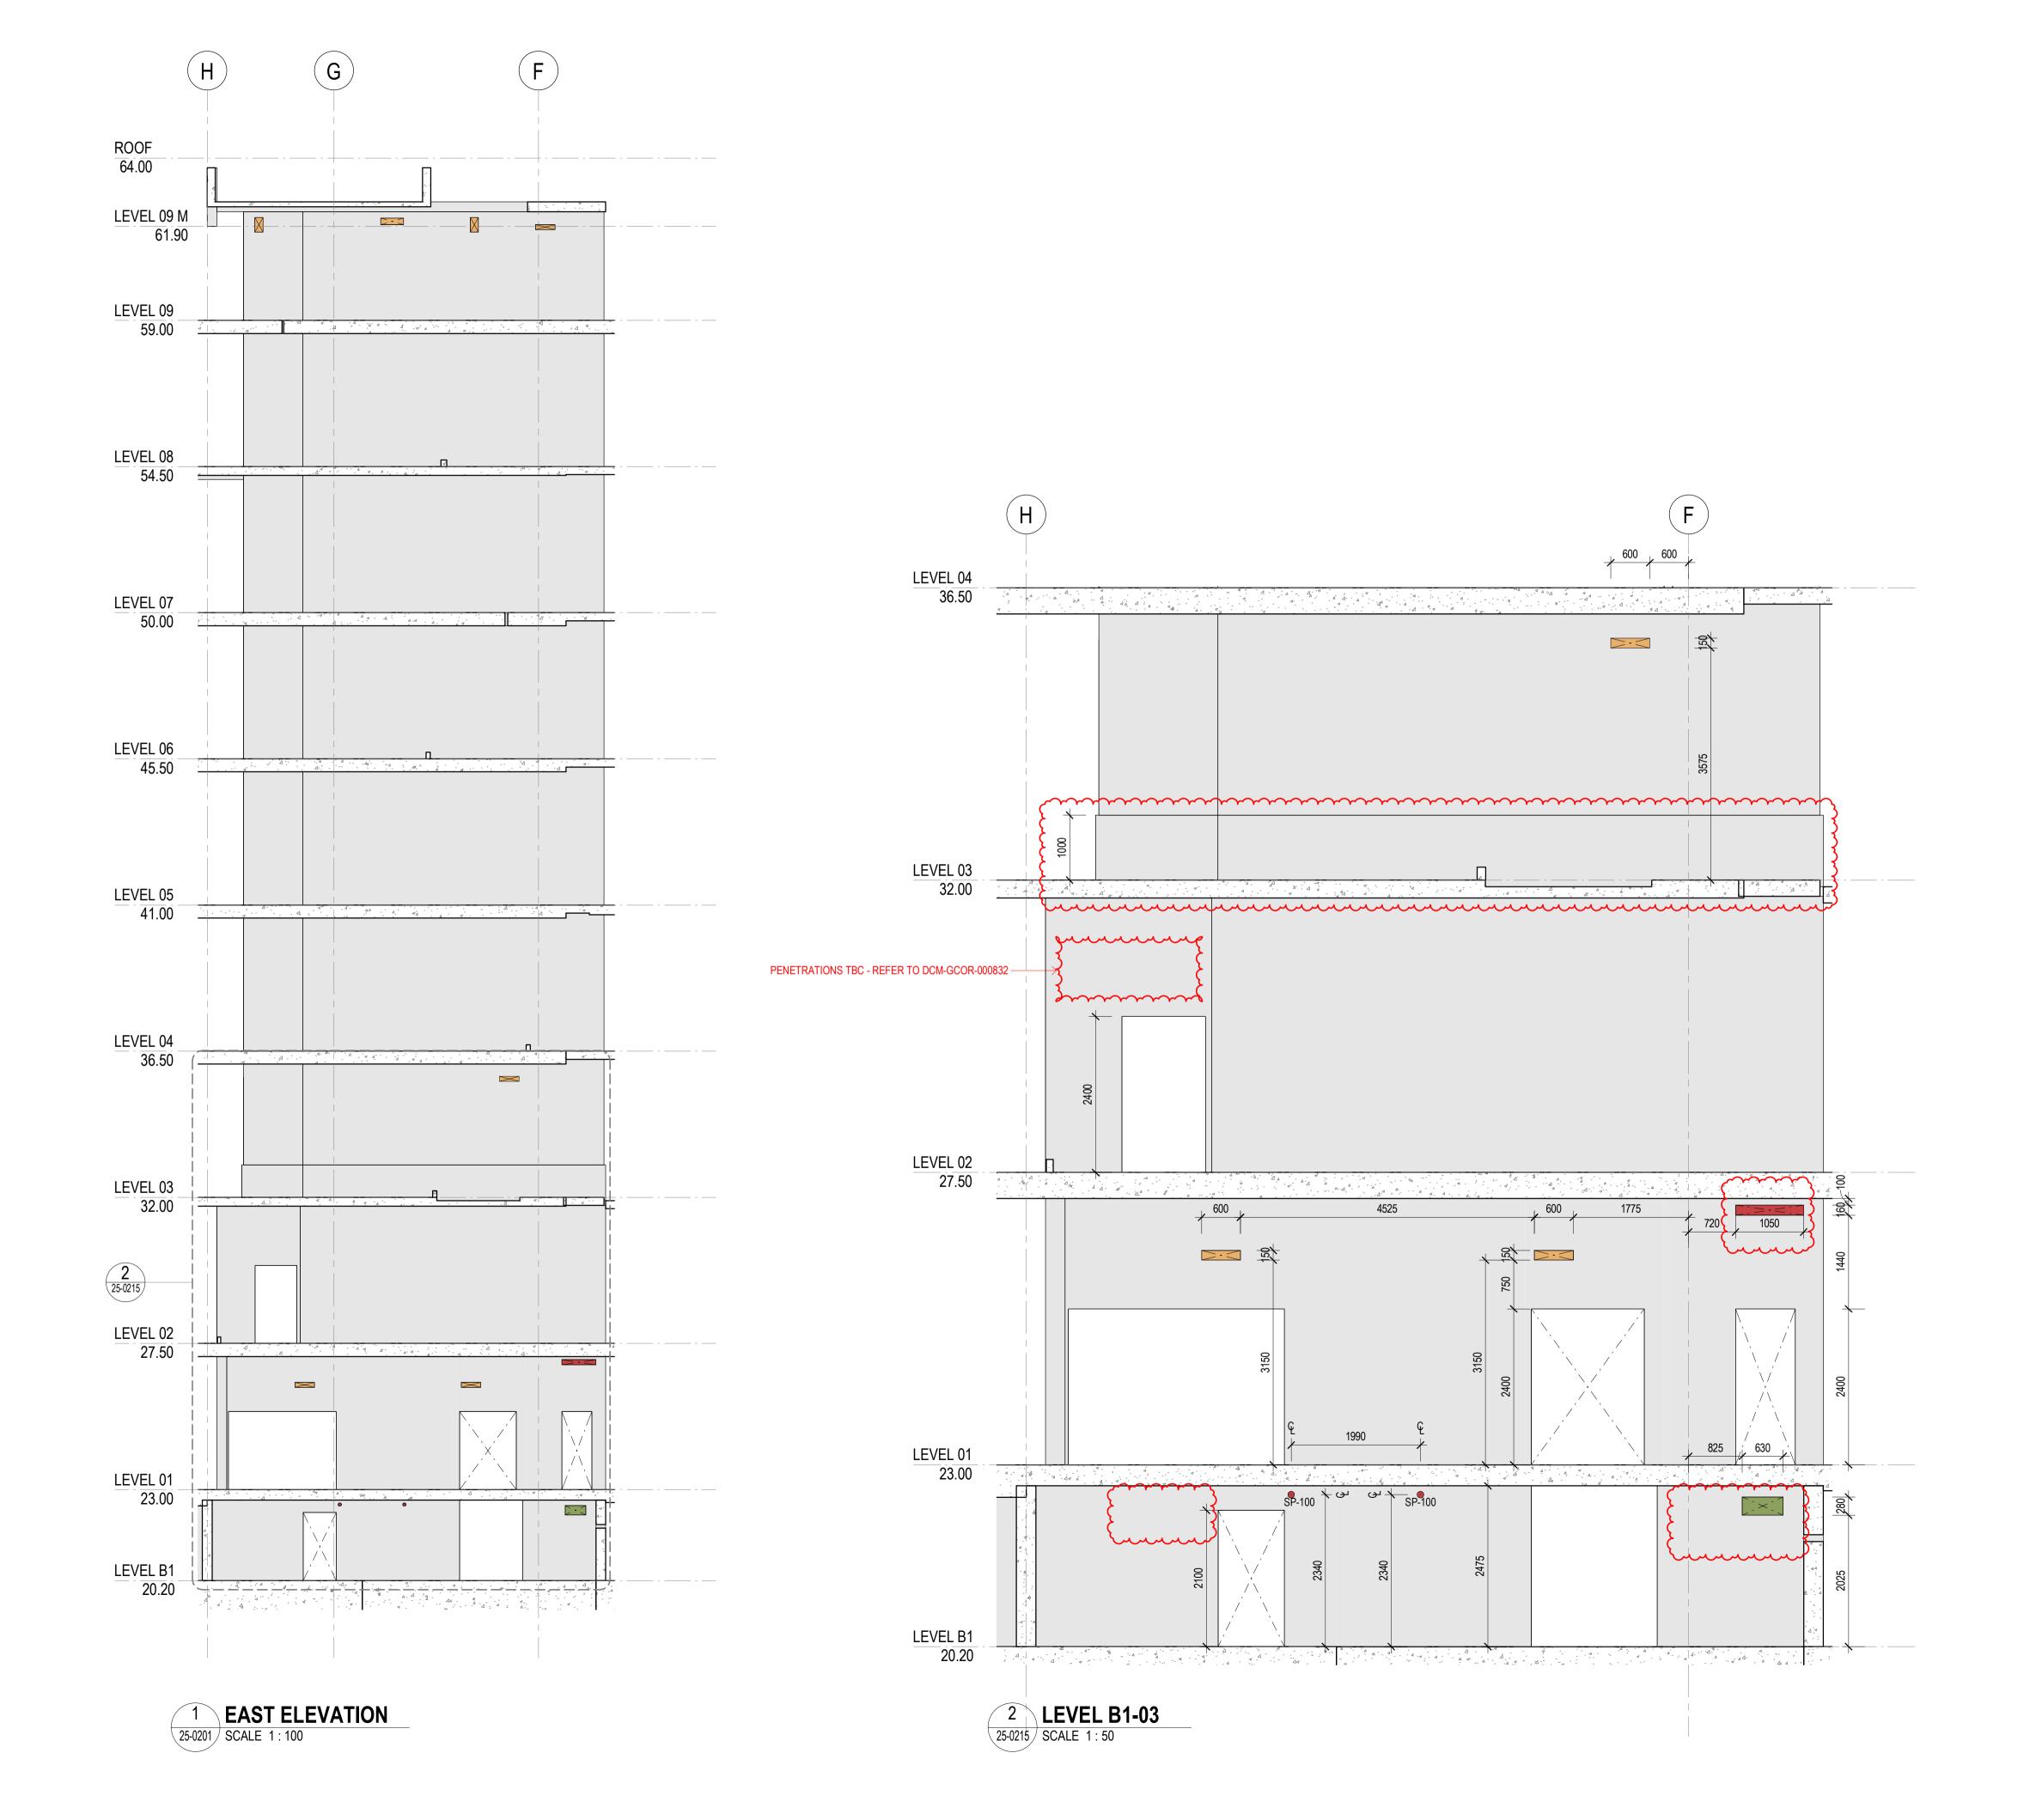PENETRATION TYPE LEGEND

MECHANICAL SHAFT / PENETRATION ELECTRICAL/COMMS SHAFT / PENETRATION HYDRAULIC SHAFT / PENETRATION

FIRE SHAFT / PENETRATION

DRAWINGS STATUS: - LEVEL 04-09 ARE NOT FOR CONSTRUCTION AS THEY ARE

NOT PART OF CC2 - SECURITY SERVICES PENETRATIONS NOT INCLUDED

(-STRUCTURAL BOOR OPENINGS AS PER RCC-GCOR-003669)

SERVICES STRUCTURAL PENETRATIONS BASED ON: - FIRE SERVICES PENETRATION AS PER EmergeFP-GCOR-000074

- MECHANICAL SERVICES PENETRATIONS AS PER FRED AIR-GCOR-000300, Hoslab-GCOR-000098, RCC-GCOR-003665, MMcD-RTRFI-000045, Fred Air-GCOR-000379 - ELECTRICAL SERVICES PENETRATIONS SIZE AS PER RCC-GCOR-003665. FURTHER COORDINATION FOR SETOUTS

- STRUCTURES AS PER RCC-GCOR-002926, MMcD-



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Scale / North Point 1:50 @ A1 0 0.5 1 1.5 2.5M 1:100 @ A3

Drawing Status FOR CONSTRUCTION

CENTRAL CORE SETOUT ELEVATIONS -SHEET 05

GG Project Number

D0353


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CROWN DEVELOPMENT APPROVED PLANS

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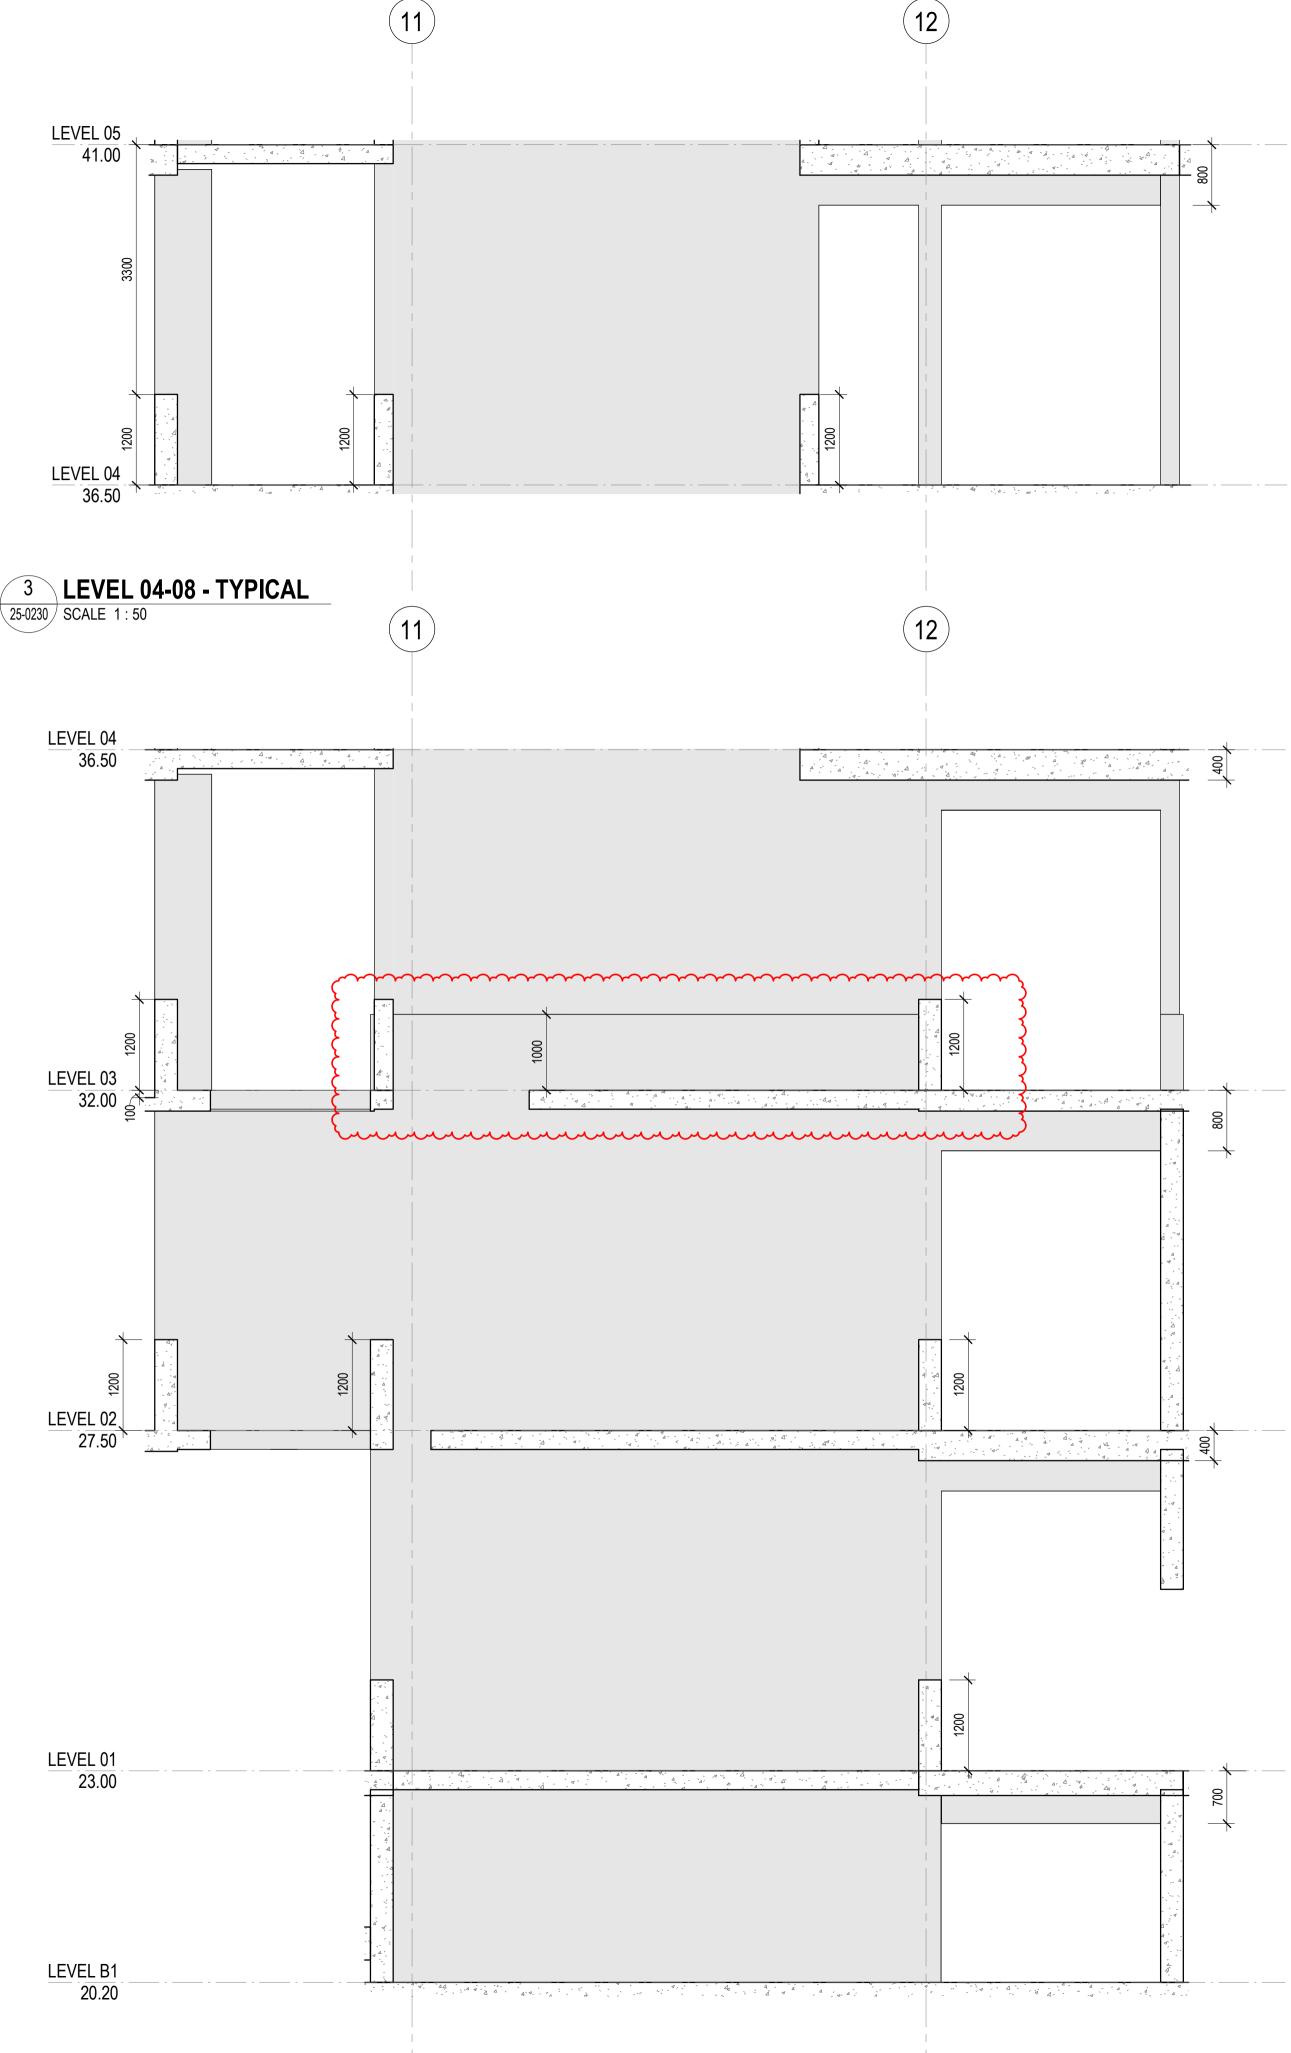
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LEVEL B1-03

25-0230 SCALE 1 : 50



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GENERAL NOTES

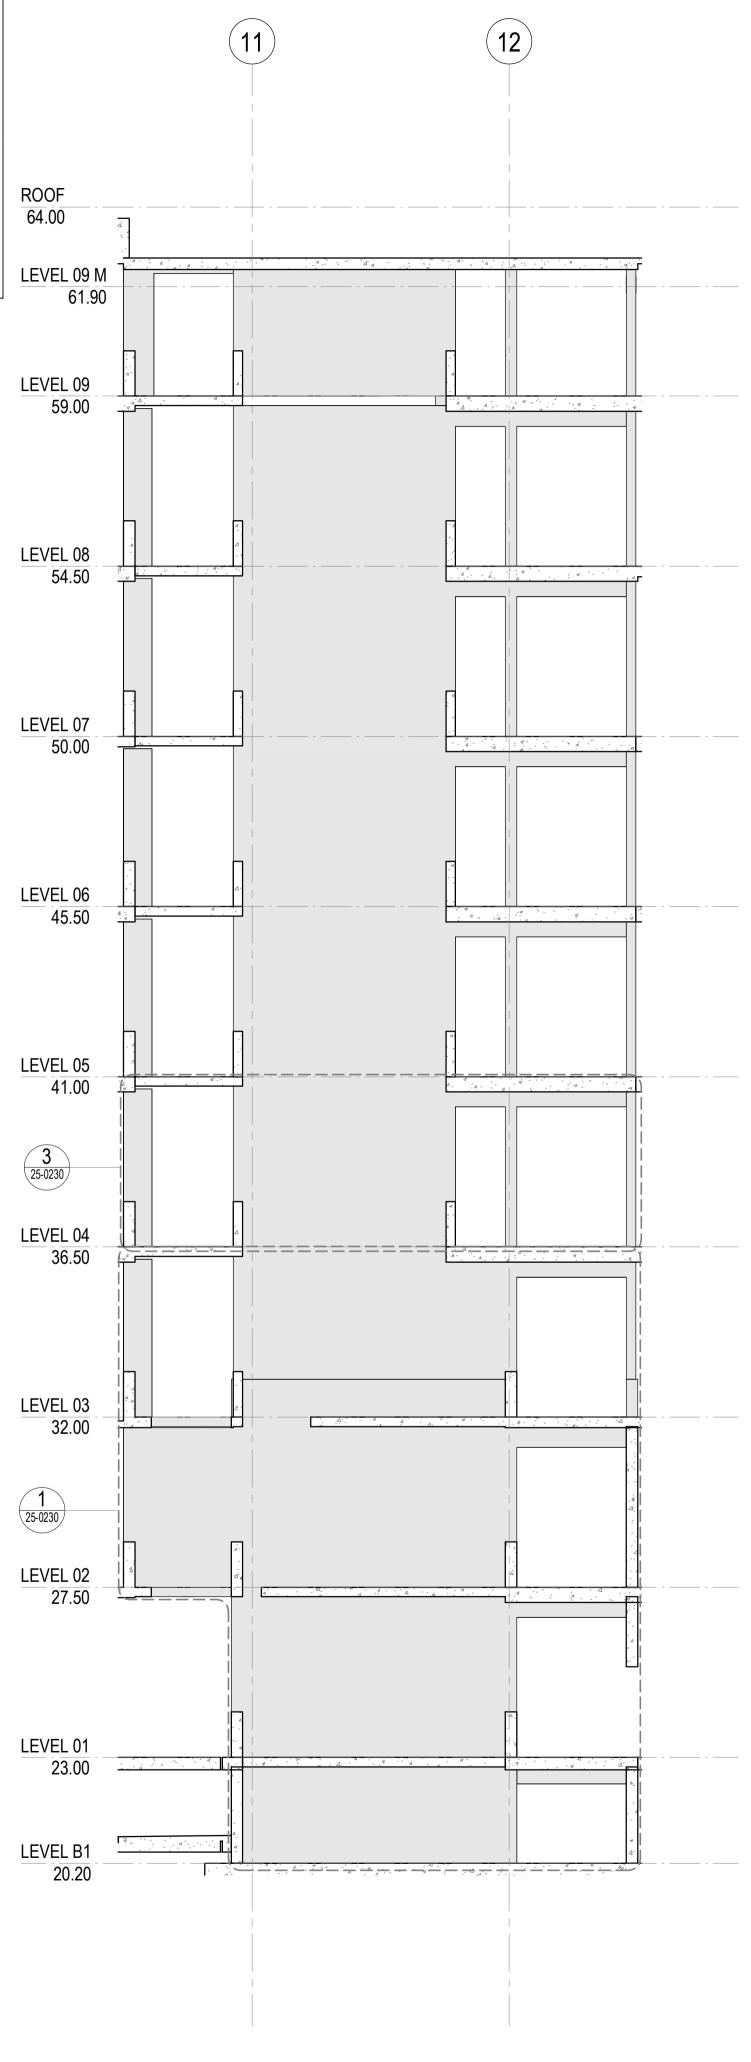1. REFER LEGENDS AND GENERAL NOTES ON DRAWING A20_0000; A20_0010; A20_0020; A20_0100 2. TO BE READ IN CONJUNCTION WITH STRUCTURAL ENGINEER'S DOCUMENTATION FOR STRUCTURES SIZE AND THICKNESS

3. PENETRATIONS SMALLER THAN 50MM DIA ARE OMITTED

LEGEND

FOUNDATION STRUCTURES. REFER TO A22 DRAWING SERIES FOR RAFT, PENETRATIONS THROUGH RAFT, AND LIFT PIT DETAILS

PENETRATION TYPE LEGEND

MECHANICAL SHAFT / PENETRATION ELECTRICAL/COMMS SHAFT / PENETRATION

HYDRAULIC SHAFT / PENETRATION FIRE SHAFT / PENETRATION

DRAWINGS STATUS:
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Drawing Status FOR CONSTRUCTION

CENTRAL CORE SETOUT SECTIONS SHEET 01

GG

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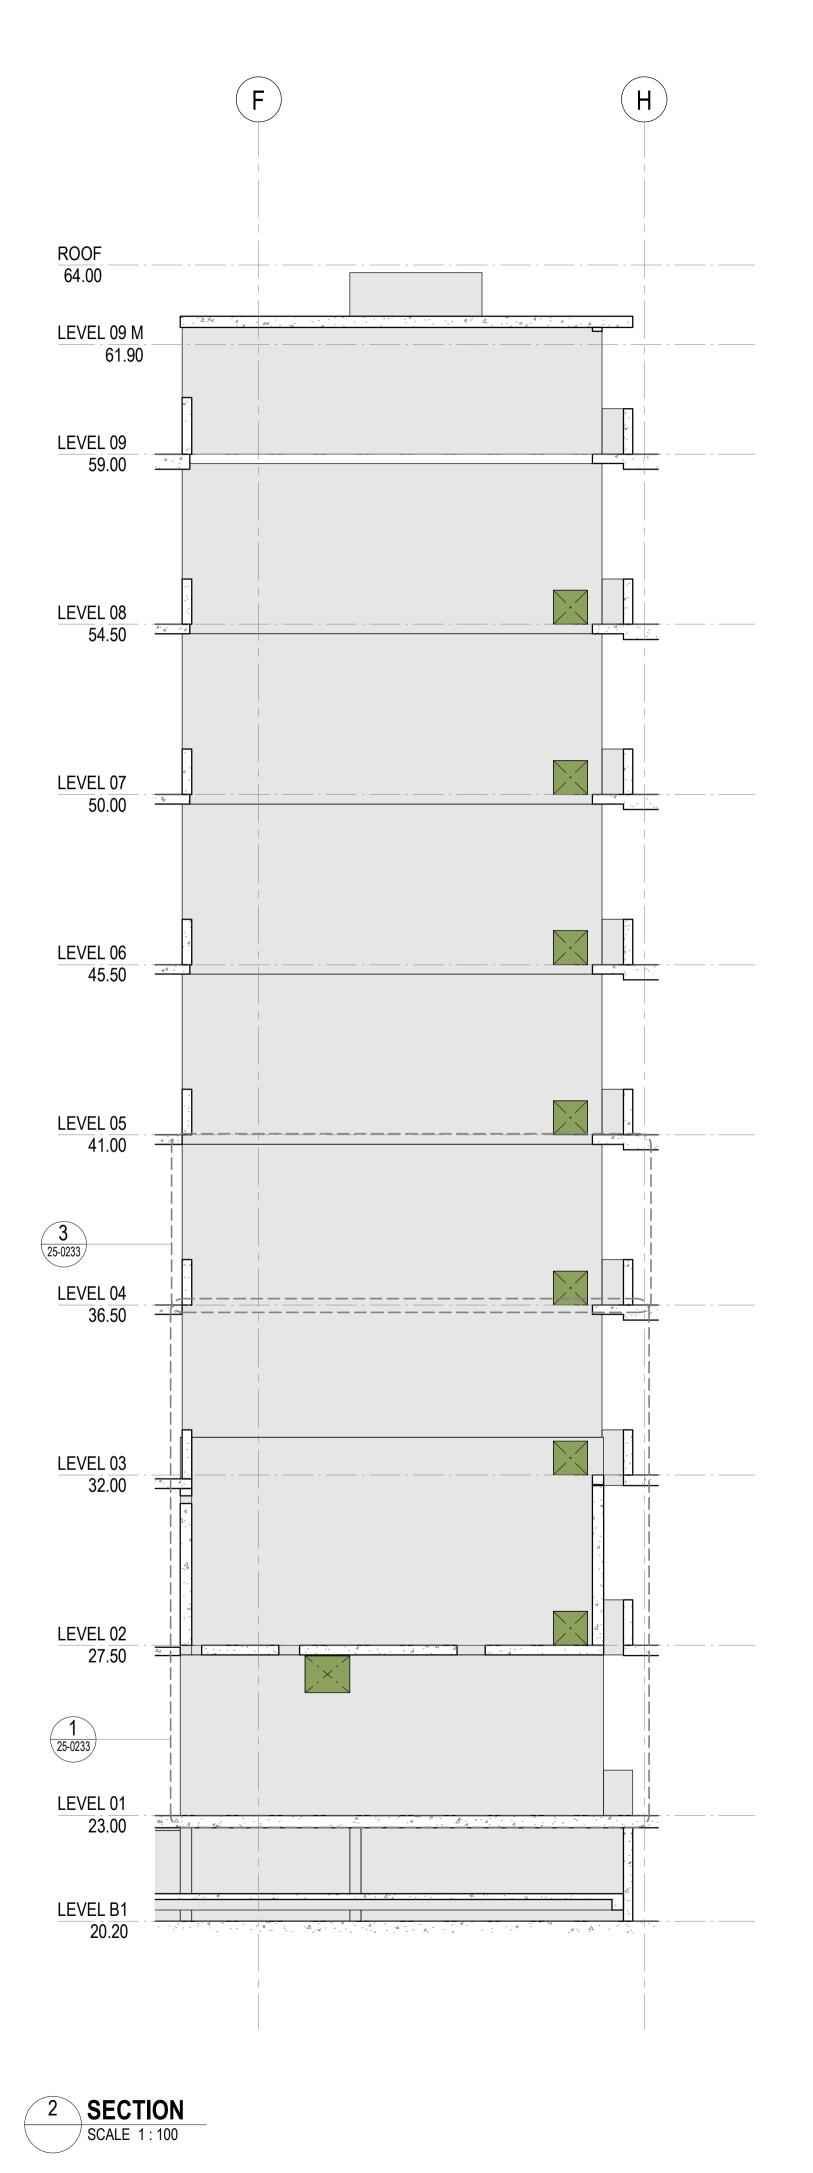
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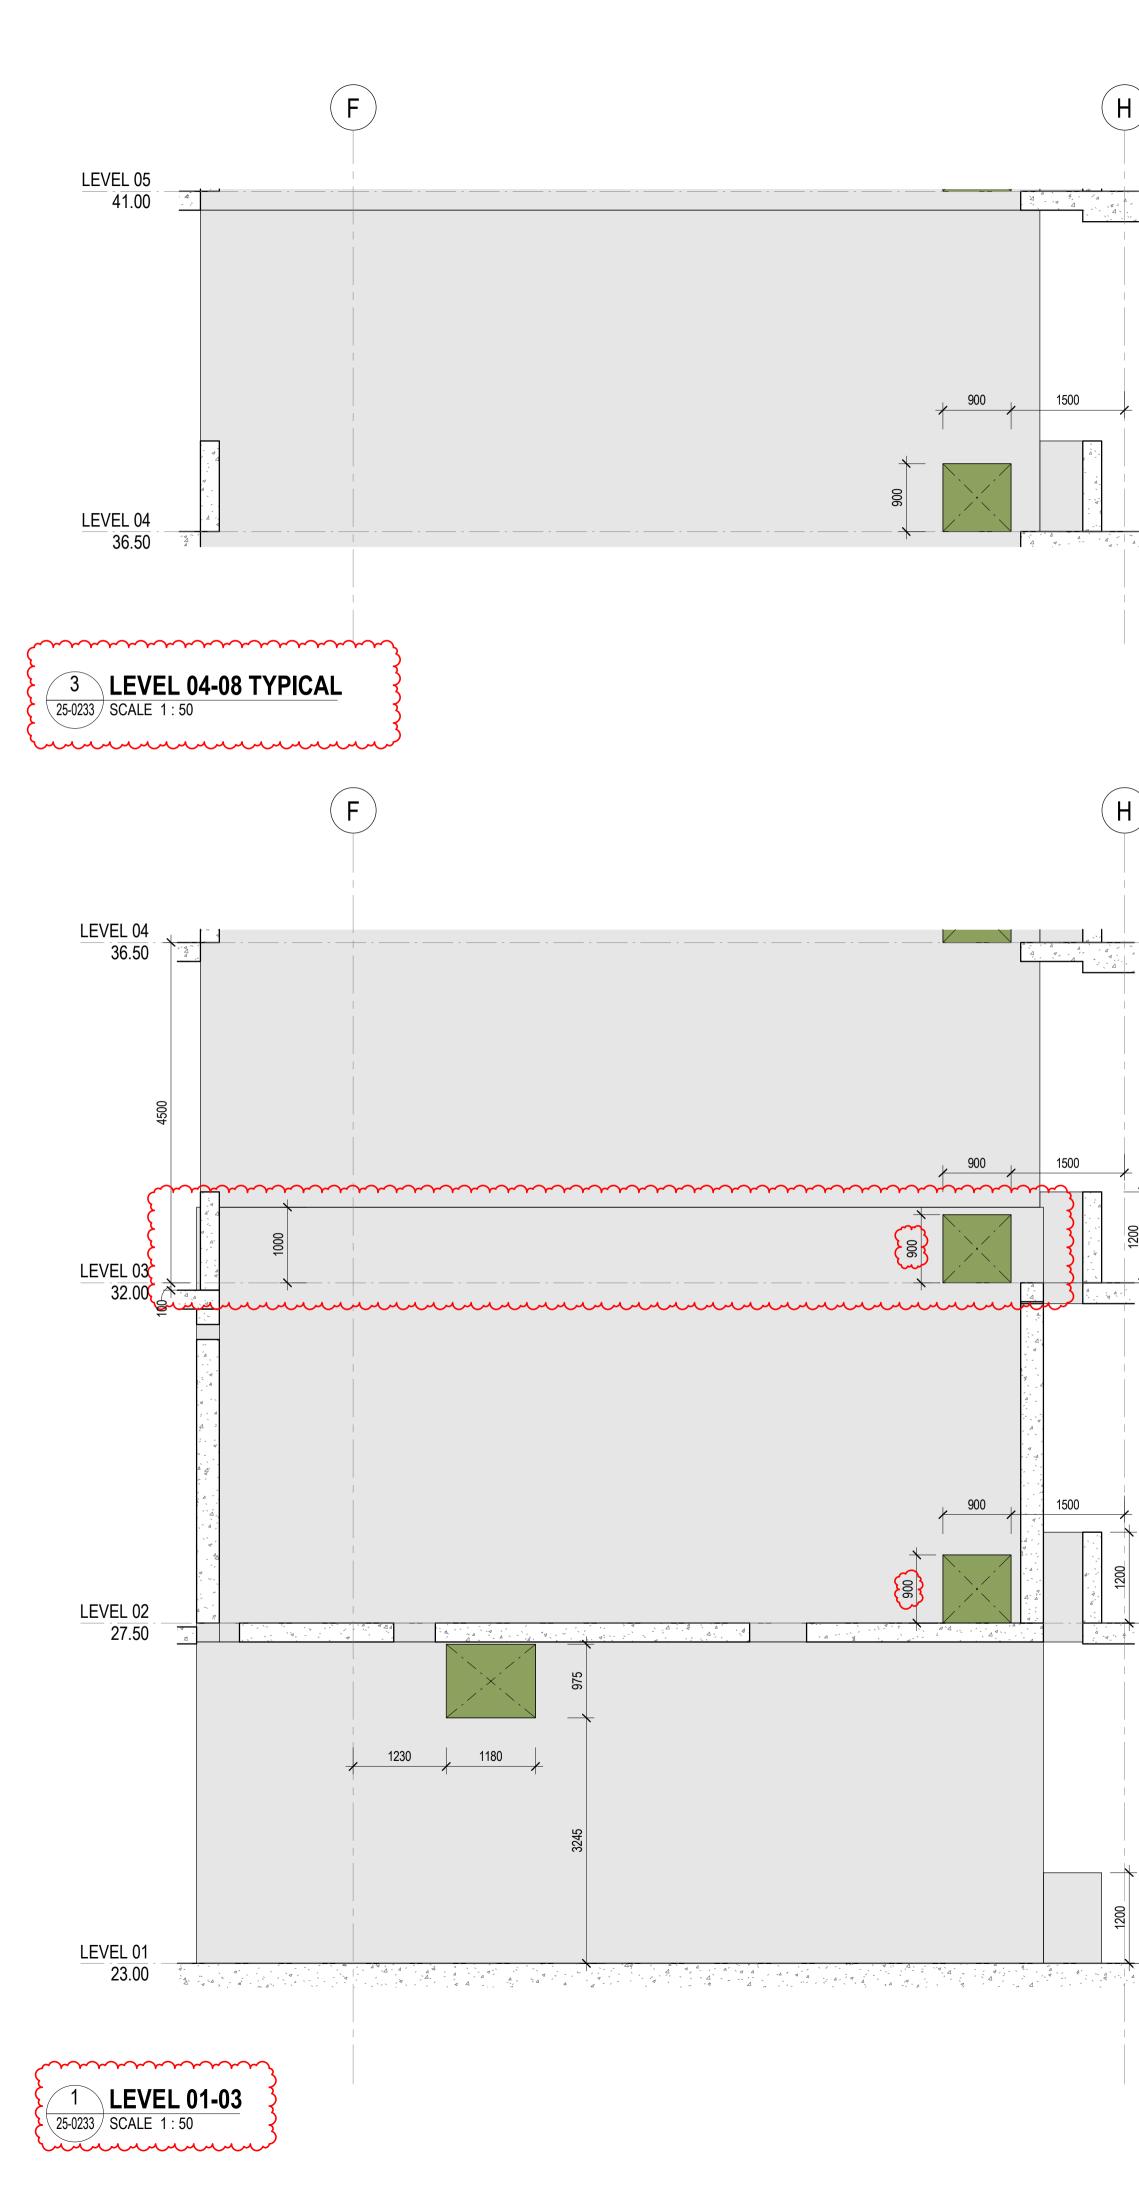
² SECTION 25-0201 SCALE 1:100

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3. PENETRATIONS SMALLER THAN 50MM DIA ARE OMITTED

LEGEND

FOUNDATION STRUCTURES. REFER TO A22 DRAWING SERIES FOR RAFT, PENETRATIONS THROUGH RAFT, AND LIFT PIT DETAILS

PENETRATION TYPE LEGEND

MECHANICAL SHAFT / PENETRATION ELECTRICAL/COMMS SHAFT / PENETRATION HYDRAULIC SHAFT / PENETRATION

FIRE SHAFT / PENETRATION

DRAWINGS STATUS:
- LEVEL 04-09 ARE NOT FOR CONSTRUCTION AS THEY ARE NOT PART OF CC2

 \cdots SERVICES STRUCTURAL PENETRATIONS BASED ON: - MECHANICAL SERVICES PENETRATIONS AS PER FRED AIR GCOR-000281, Hoslab-GCOR-000087, RCC-GCOR-003665,



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Scale / North Point 1:50 @ A1 0 0.5 1 1.5 2.5M 1:100 @ A3

Drawing Status FOR CONSTRUCTION

CENTRAL CORE SETOUT SECTIONS SHEET 03

Project Number D0353

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Drawing Number D19-A-X-25-0233


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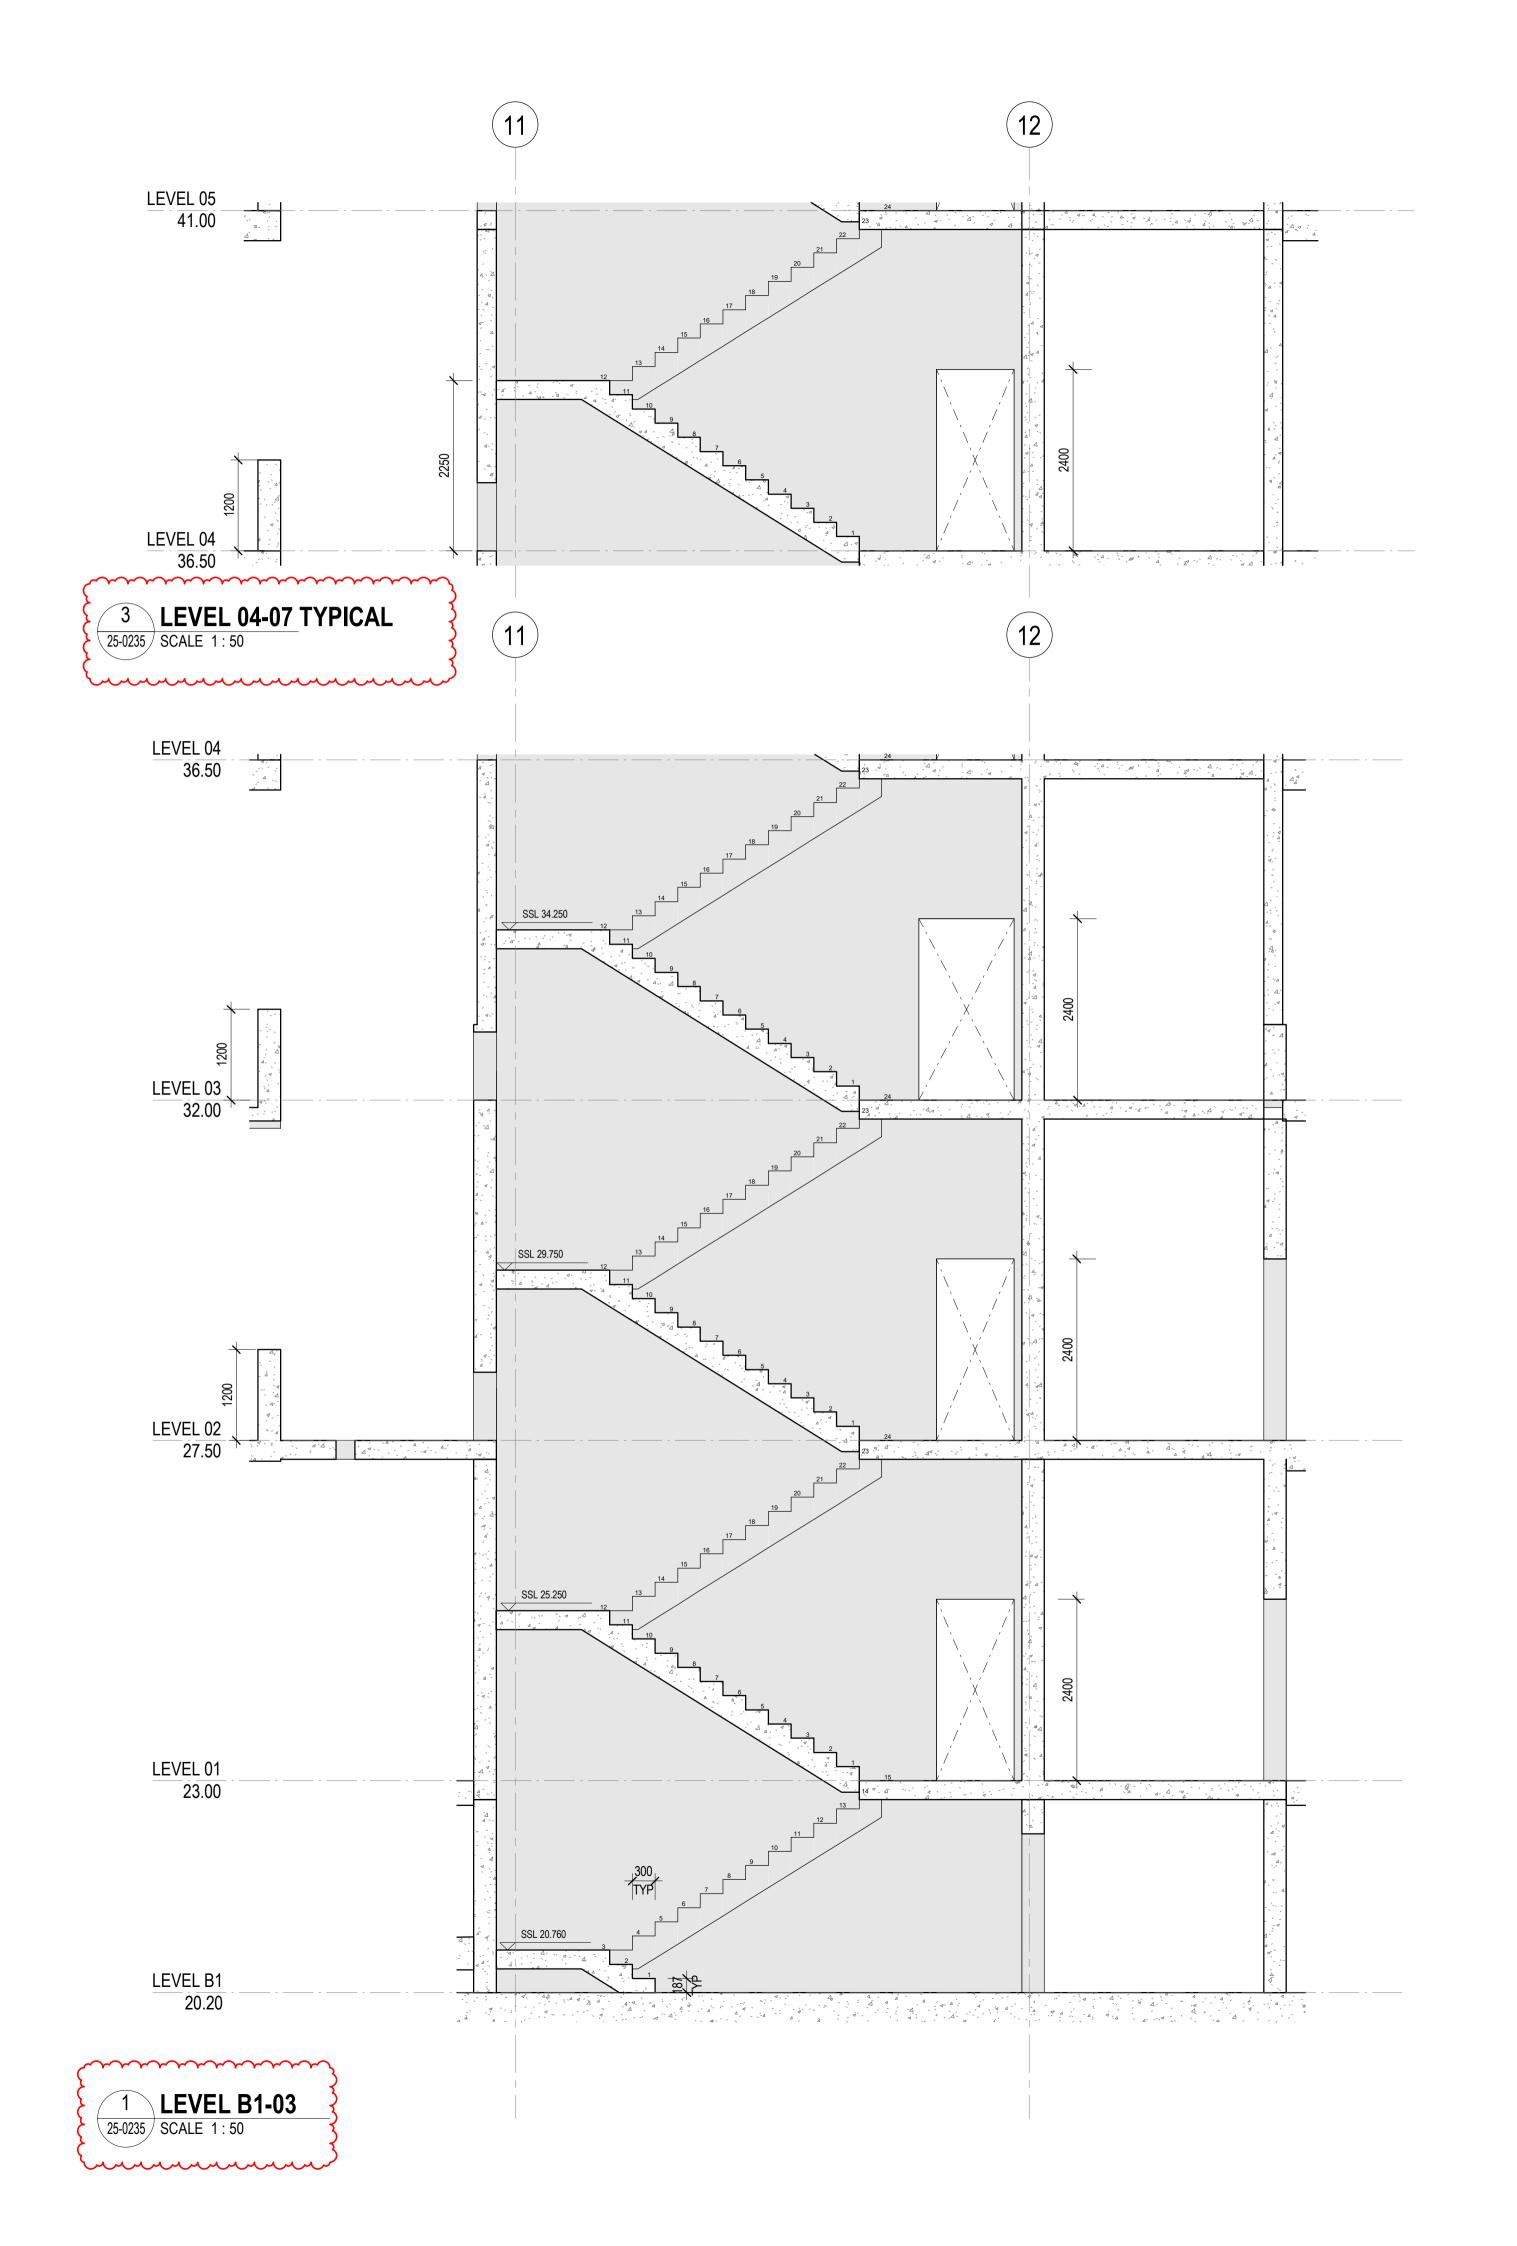
CROWN DEVELOPMENT APPROVED PLANS

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AND THICKNESS 3. PENETRATIONS SMALLER THAN 50MM DIA ARE OMITTED

LEGEND

FOUNDATION STRUCTURES. REFER TO A22 DRAWING SERIES FOR RAFT, PENETRATIONS THROUGH RAFT, AND LIFT PIT DETAILS

PENETRATION TYPE LEGEND

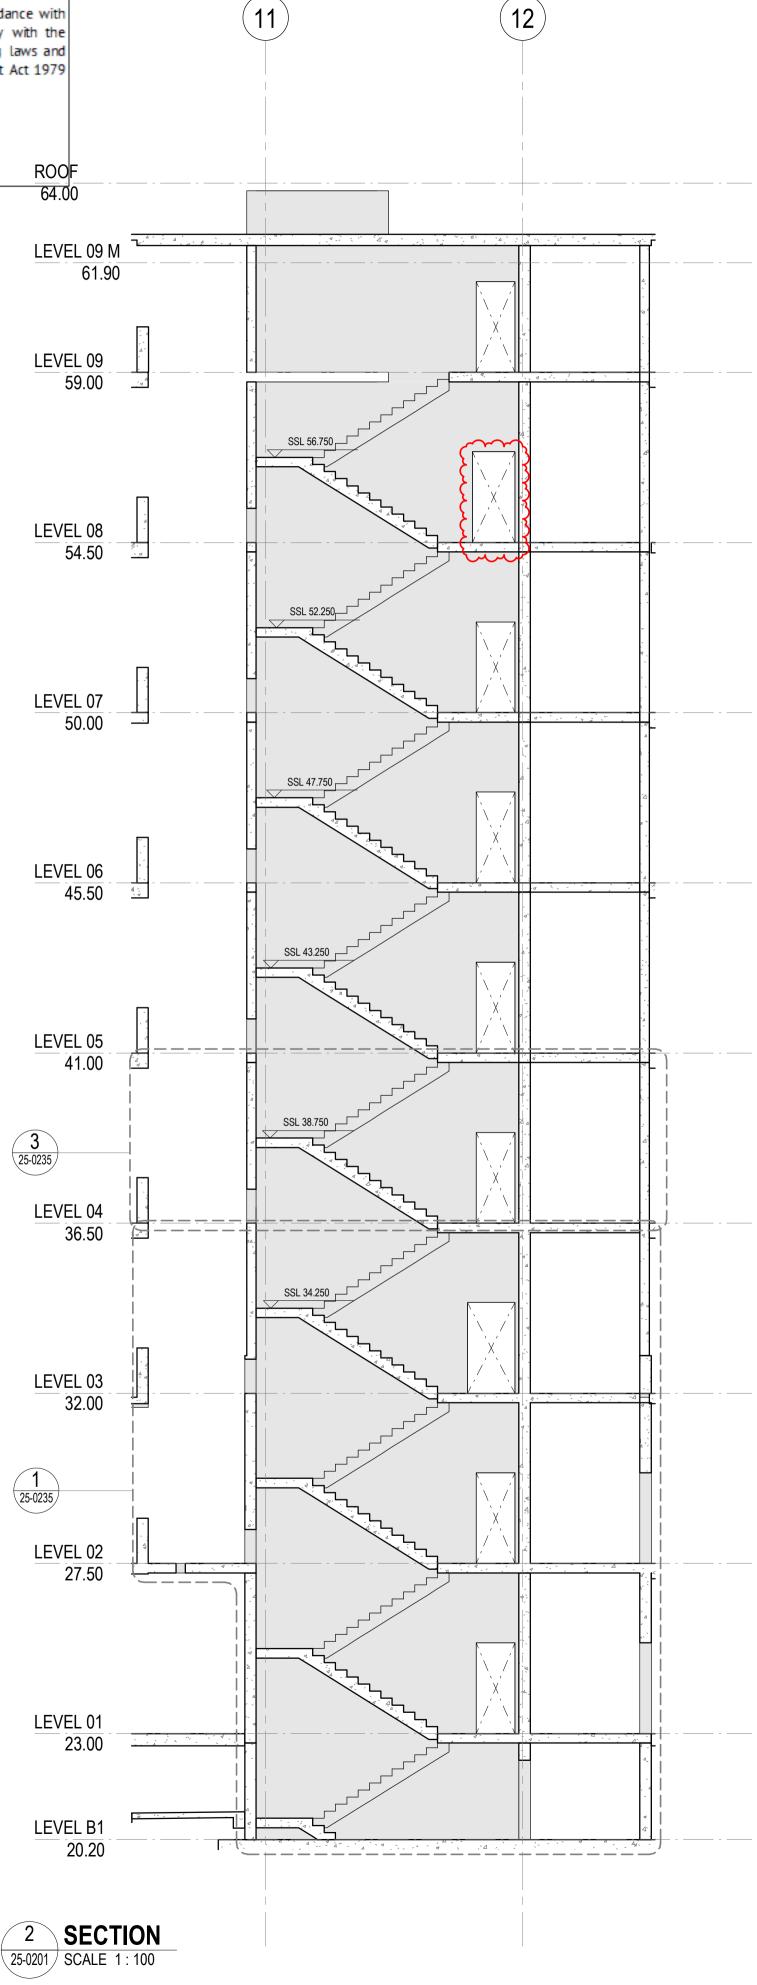MECHANICAL SHAFT / PENETRATION ELECTRICAL/COMMS SHAFT / PENETRATION HYDRAULIC SHAFT / PENETRATION

FIRE SHAFT / PENETRATION

DRAWINGS STATUS:
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Scale / North Point

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Drawing Status FOR CONSTRUCTION

CENTRAL CORE SETOUT SECTIONS SHEET 05


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Project Number Drawing Number D0353 D19-A-X-25-0235

22/10/2025 6:03:03 PM 22/10/2025

S6.28 No. 25000287 / 9 CROWN DEVELOPMENT APPROVED PLANS I certify that the work completed in accordance with these plans and specifications will comply with the technical provisions of the State's building laws and the Environmental Planning and Assessment Act 1979 MBC Corporate Accreditation RBC00029 10 Nov 2025 ROOF 64.00 LEVEL 09 M 61.90 LEVEL 09 59.00 LEVEL 08 54.50 LEVEL 07 50.00 LEVEL 06 45.50 LEVEL 05 41.00 LEVEL 04 36.50 LEVEL 03 32.00 25-0237 LEVEL 02 27.50 LEVEL 01 23.00 LEVEL B1 20.20 +-----1 **SECTION** 25-0201 SCALE 1:100

No. 203

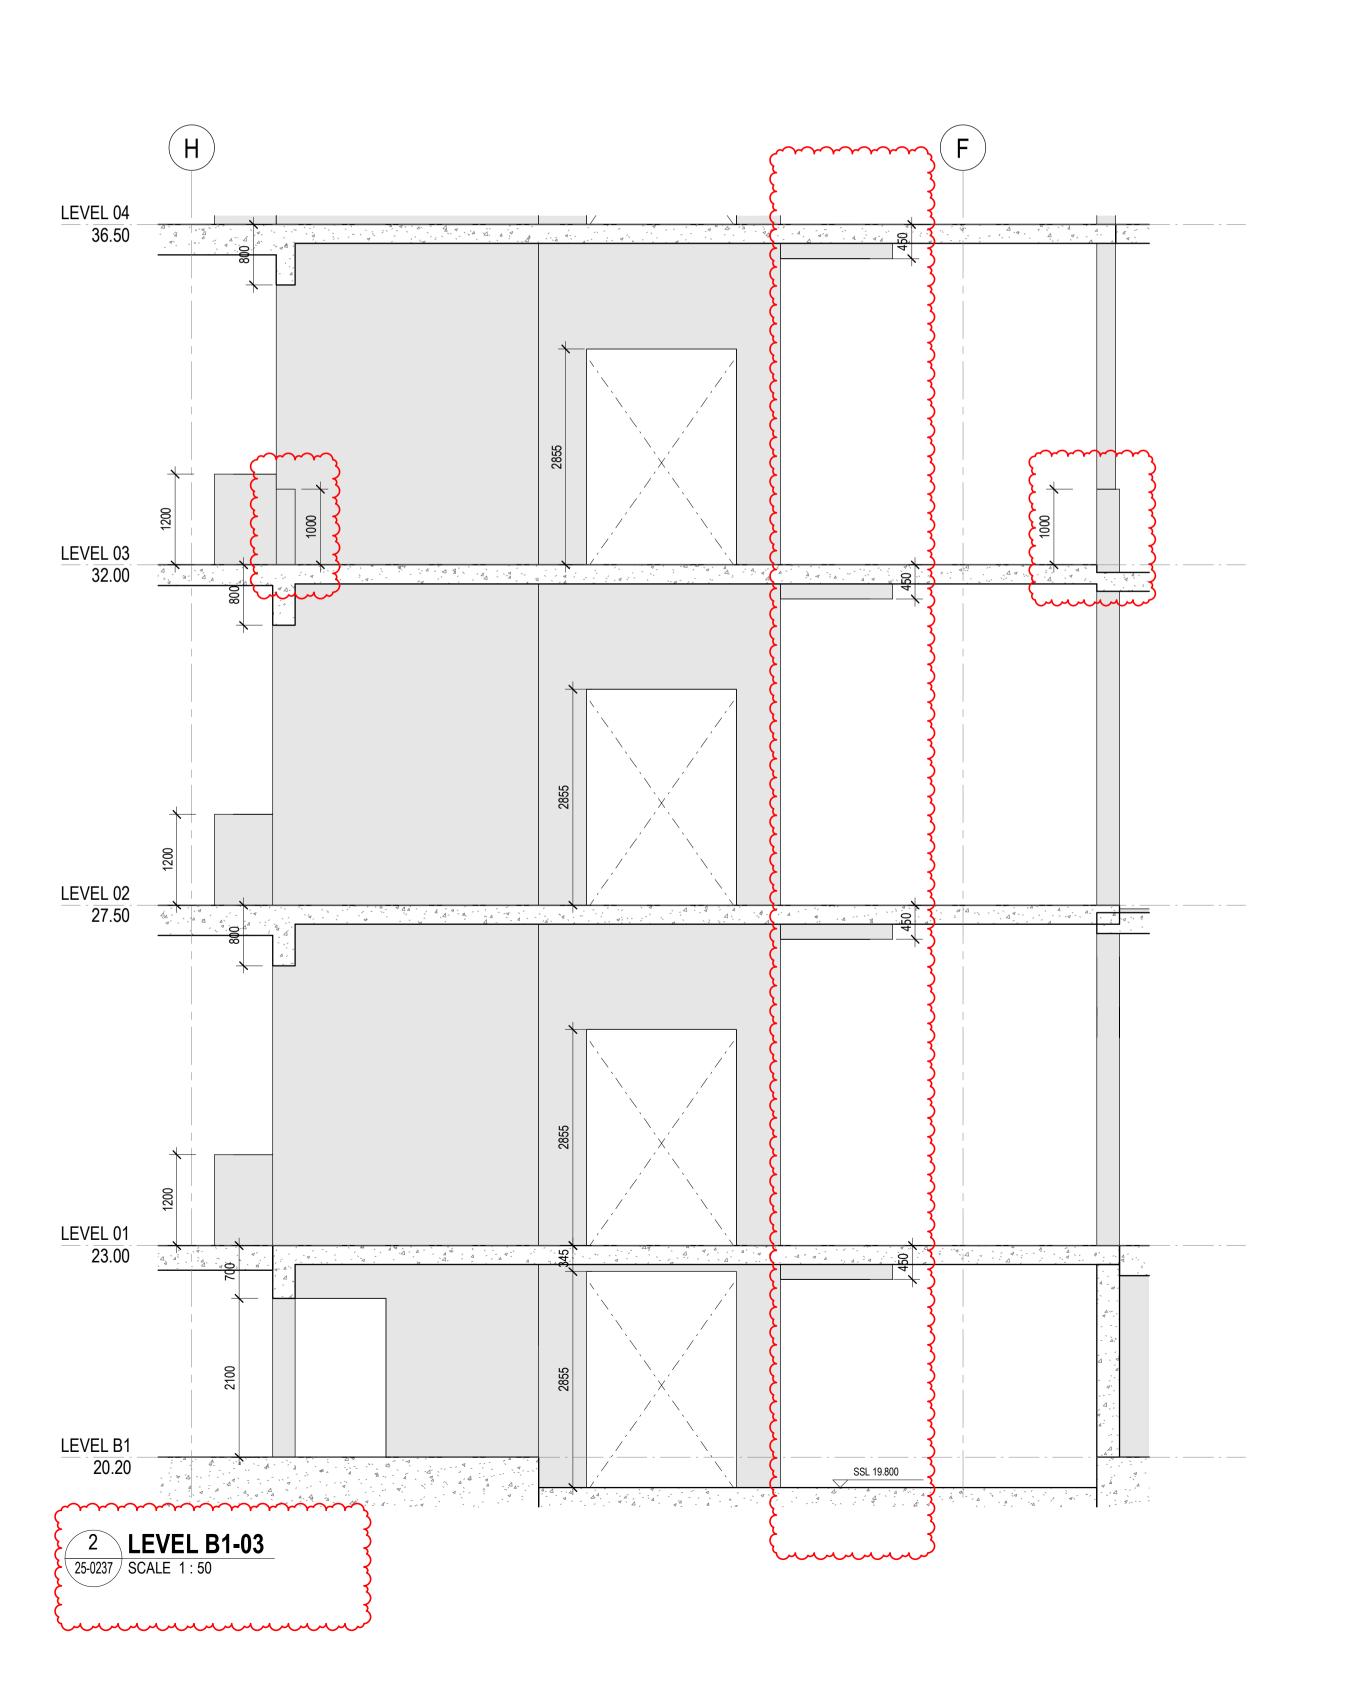

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GENERAL NOTES

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3. PENETRATIONS SMALLER THAN 50MM DIA ARE OMITTED

LEGEND

FOUNDATION STRUCTURES. REFER TO A22 DRAWING SERIES FOR RAFT, PENETRATIONS THROUGH RAFT, AND LIFT PIT DETAILS

PENETRATION TYPE LEGEND

MECHANICAL SHAFT / PENETRATION ELECTRICAL/COMMS SHAFT / PENETRATION HYDRAULIC SHAFT / PENETRATION

FIRE SHAFT / PENETRATION

DRAWINGS STATUS:
- LEVEL 04-09 ARE NOT FOR CONSTRUCTION AS THEY ARE NOT PART OF CC2

SERVICES STRUCTURAL PENETRATIONS BASED ON:
- STRUCTURES AS PER RCC-GCOR-002926, DCM-GCOR-000627, MMcD-GCOR-000406, RCC-GCOR-003665, MMcD-GCOR-000422



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Scale / North Point

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Drawing Status FOR CONSTRUCTION

CENTRAL CORE SETOUT SECTIONS SHEET 07


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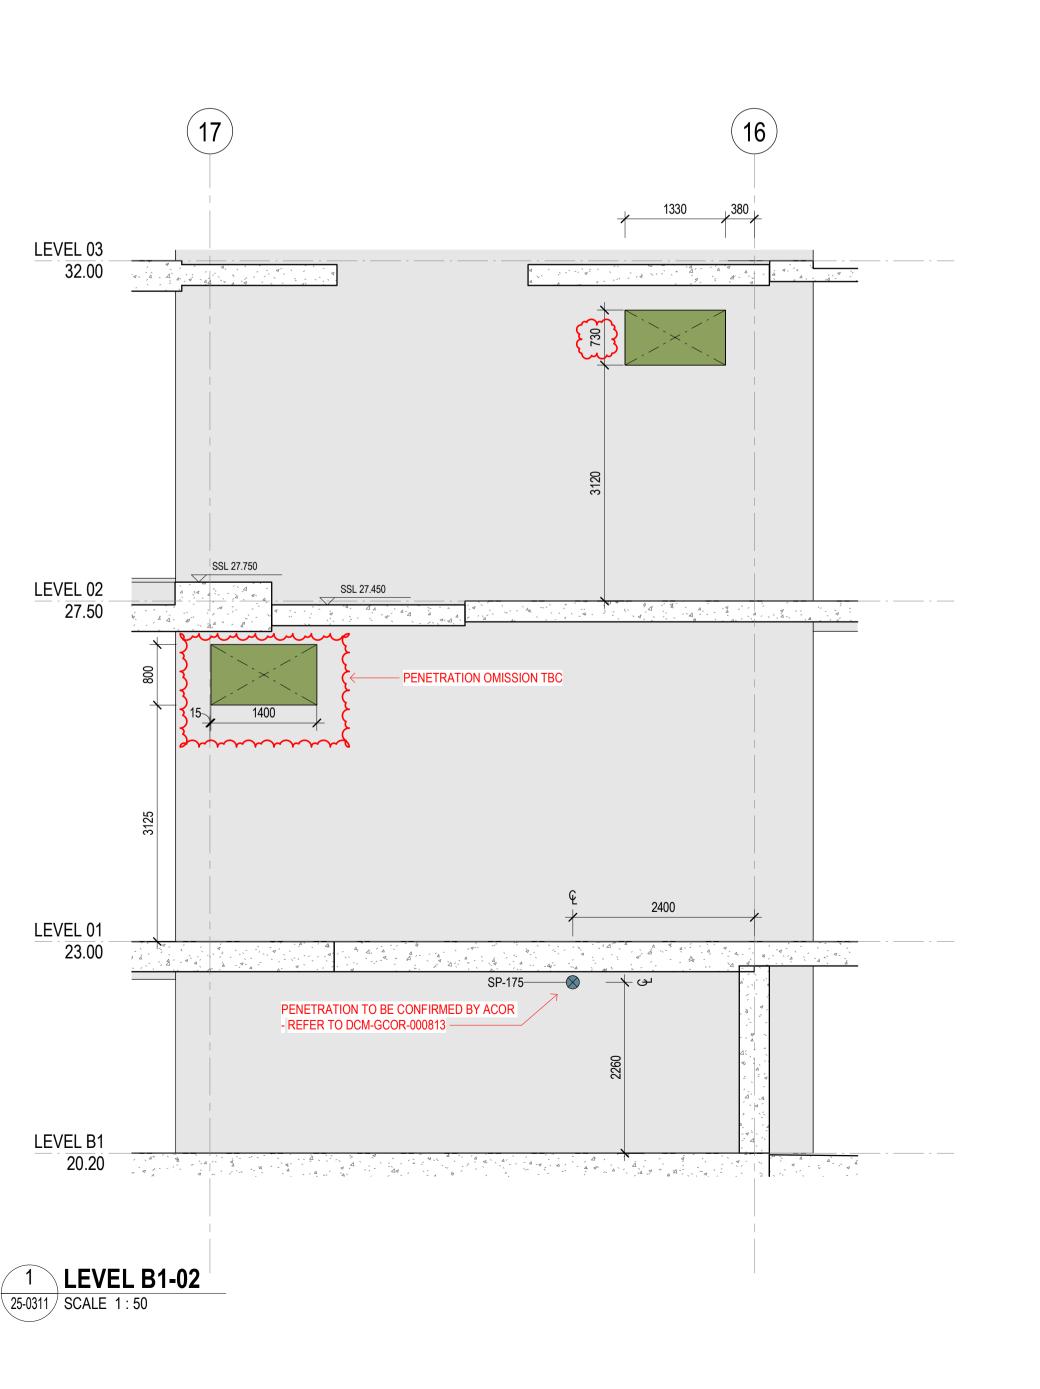
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Drawing Number D19-A-X-25-0237

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GENERAL NOTES

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3. PENETRATIONS SMALLER THAN 50MM DIA ARE OMITTED

LEGEND

FOUNDATION STRUCTURES. REFER TO A22 DRAWING SERIES FOR RAFT, PENETRATIONS THROUGH RAFT, AND LIFT PIT DETAILS

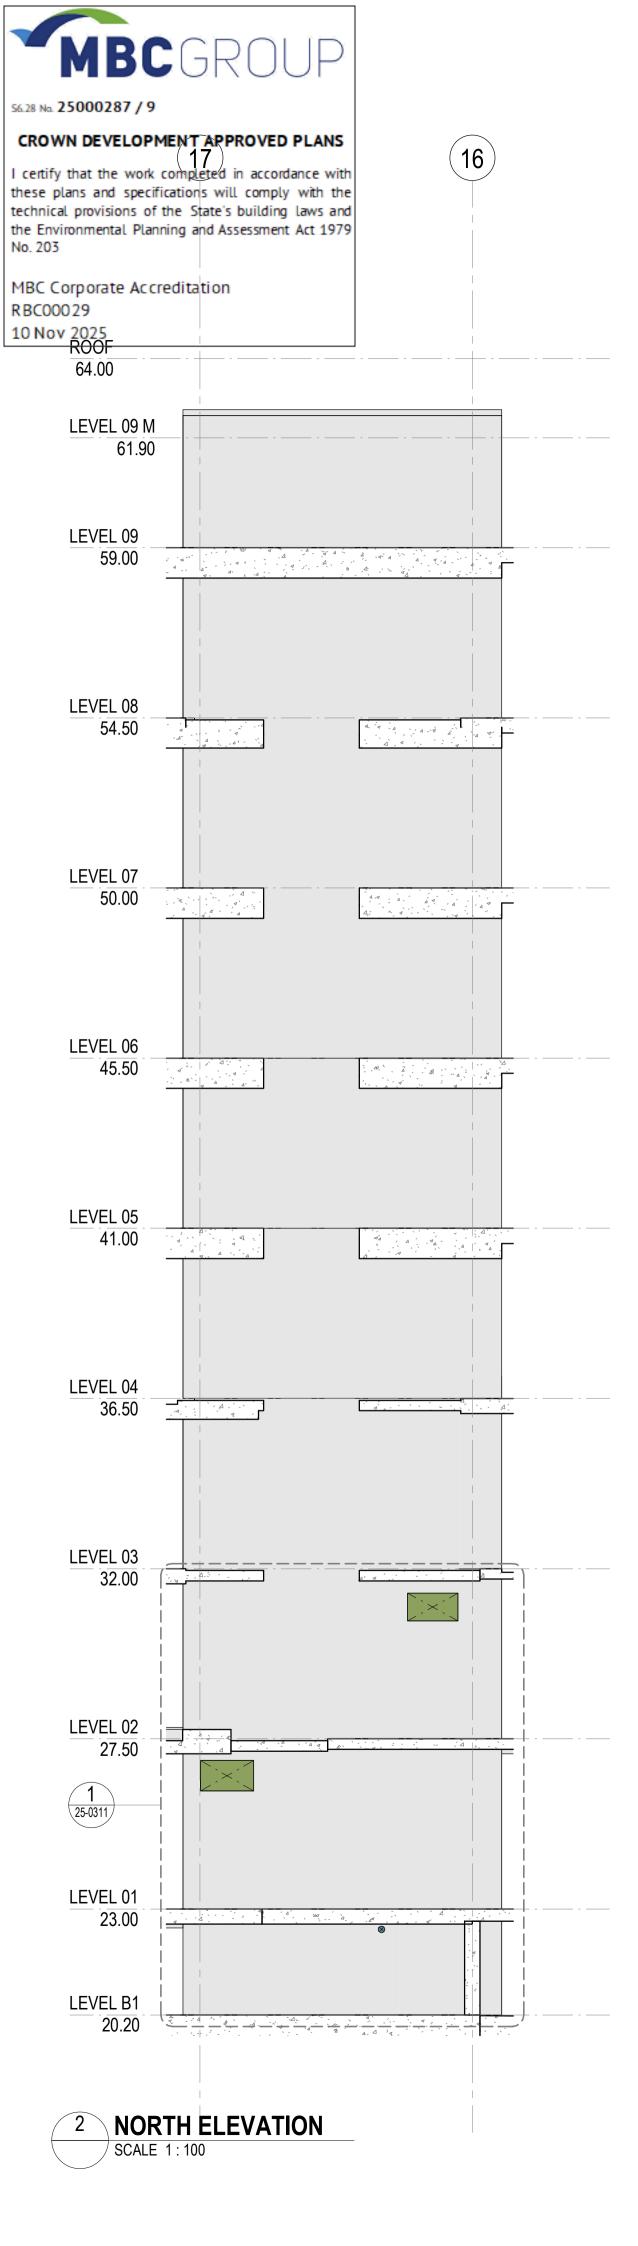PENETRATION TYPE LEGEND

MECHANICAL SHAFT / PENETRATION ELECTRICAL/COMMS SHAFT / PENETRATION HYDRAULIC SHAFT / PENETRATION

FIRE SHAFT / PENETRATION

DRAWINGS STATUS:
- LEVEL 04-09 ARE NOT FOR CONSTRUCTION AS THEY ARE NOT PART OF CC2

SERVICES STRUCTURAL PENETRATIONS BASED ON: - HYDRAULIC SERVICES PENETRATIONS AS PER HYDRAULIC SERVICES MODEL, RCC-GCOR-003665 - MECHANICAL AND GAS SERVICES PENETRATIONS AS PER Fred Air-GCOR-000307, RCC-GCOR-003665, MMcD-RTRFI-000045. Fred Air-GCOR-000404



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Scale / North Point

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CG

Drawing Status FOR CONSTRUCTION

SLHD-ESU@health.nsw.gov.au


EASTERN CORE SETOUT ELEVATIONS -SHEET 01


Project Number D0353

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Drawing Number Revision D19-A-X-25-0311 C

21/10/2025 5:26:09 PM 21/10/2025



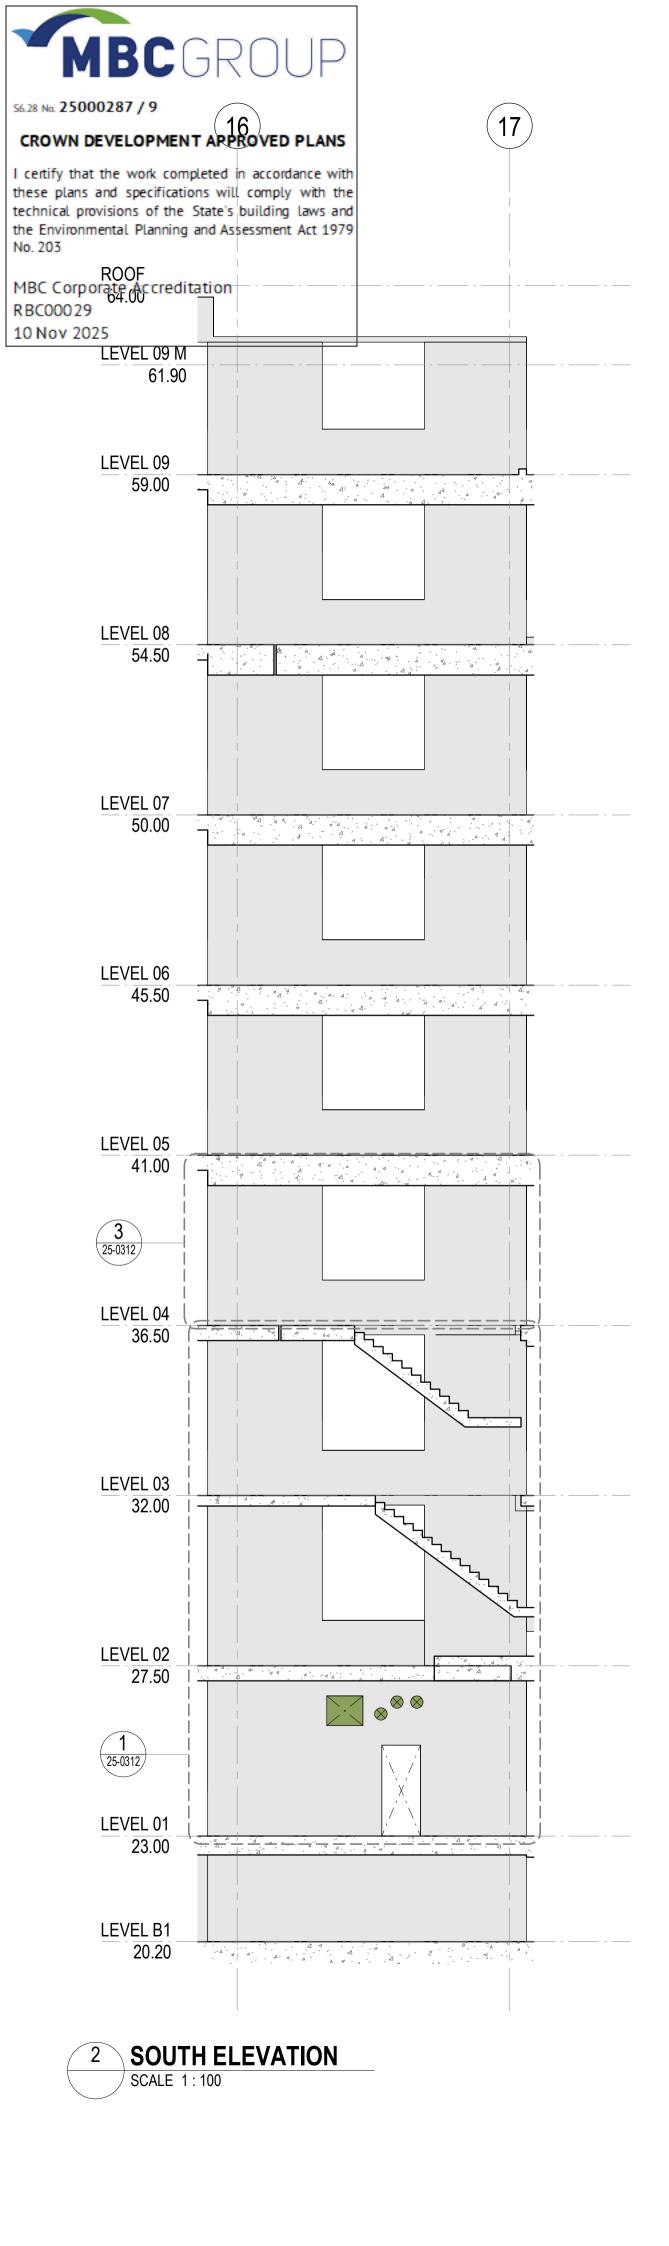
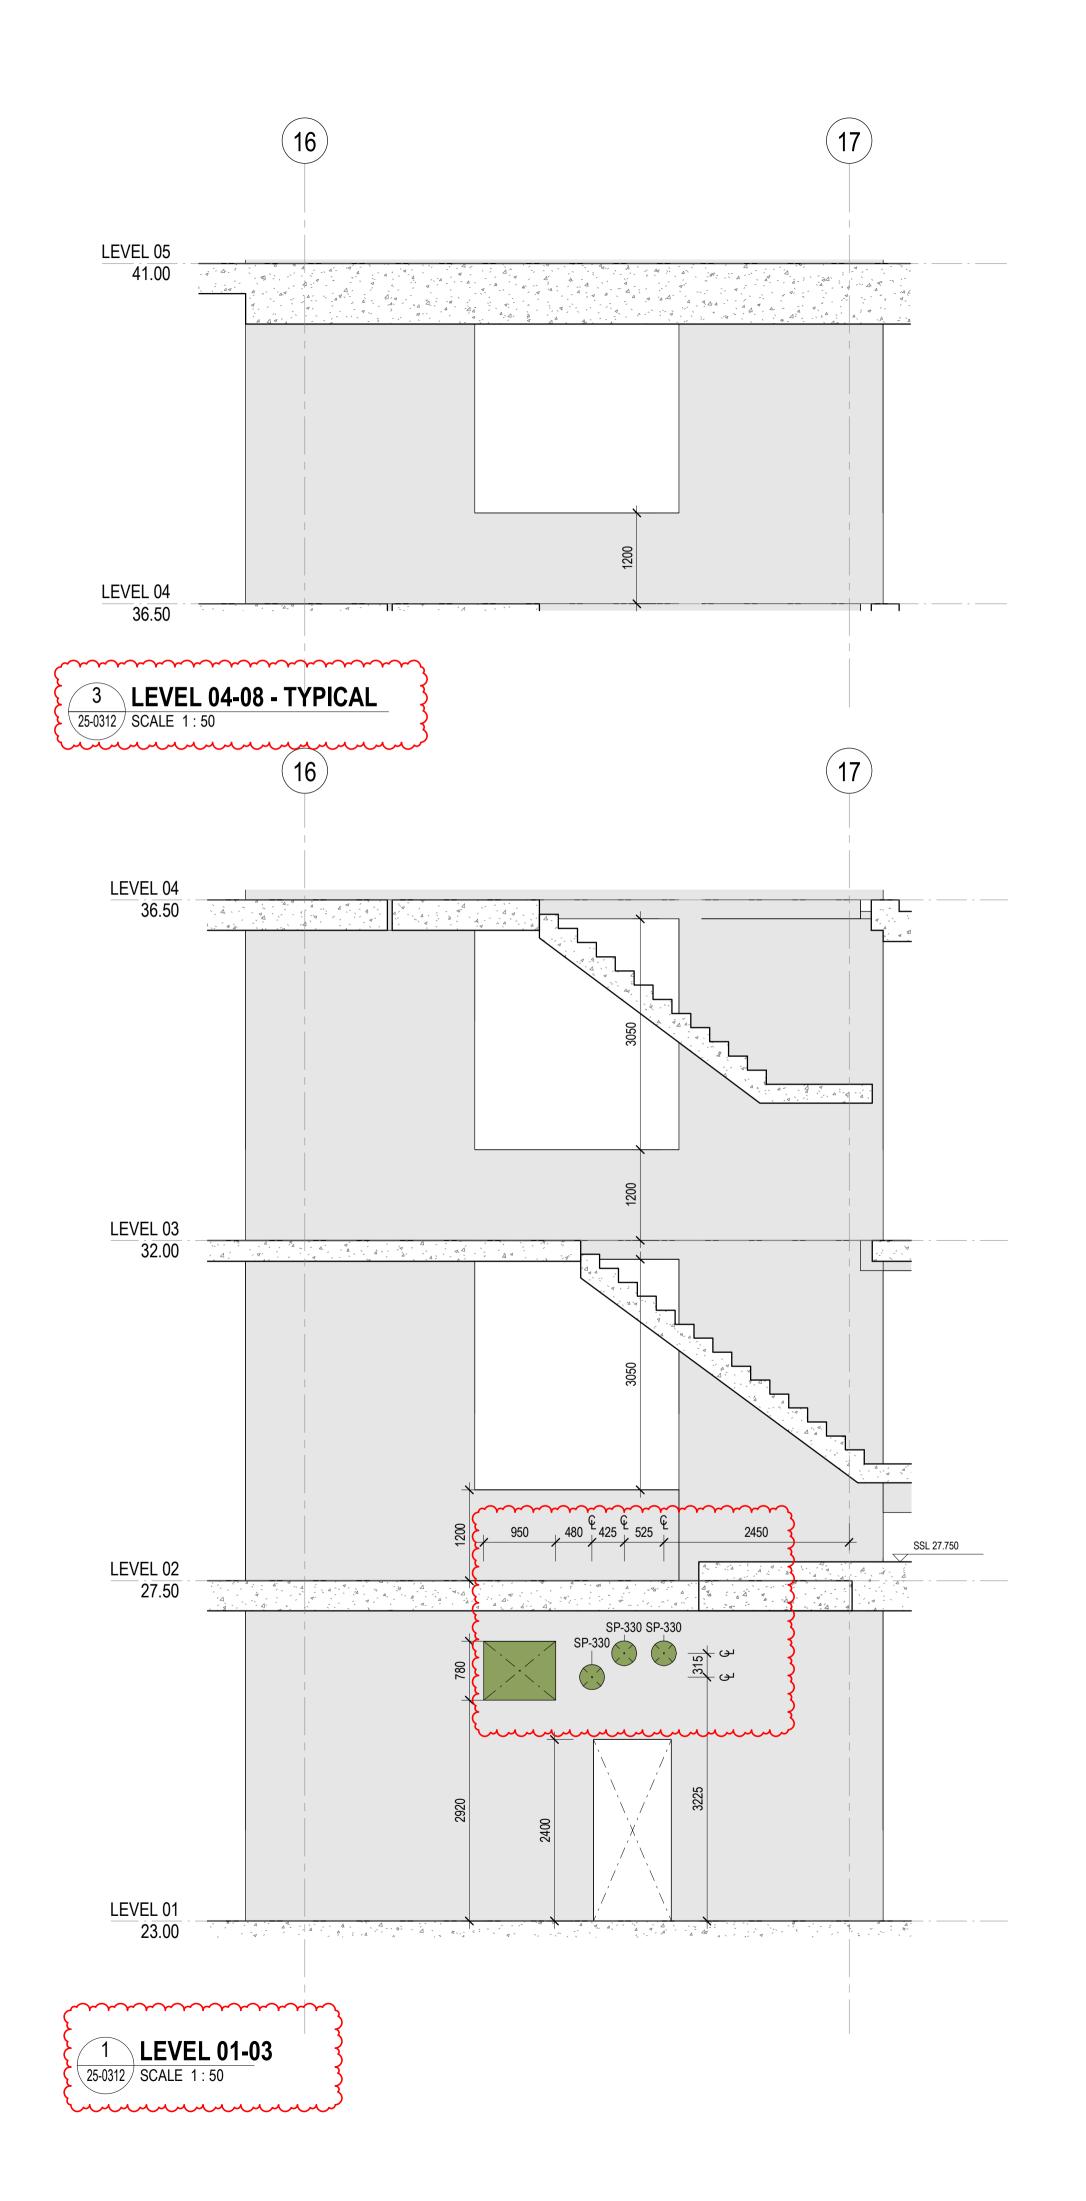
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GENERAL NOTES

1. REFER LEGENDS AND GENERAL NOTES ON DRAWING A20_0000; A20_0010; A20_0020; A20_0100 2. TO BE READ IN CONJUNCTION WITH STRUCTURAL ENGINEER'S DOCUMENTATION FOR STRUCTURES SIZE AND THICKNESS

3. PENETRATIONS SMALLER THAN 50MM DIA ARE OMITTED

LEGEND

FOUNDATION STRUCTURES. REFER TO A22 DRAWING SERIES FOR RAFT, PENETRATIONS THROUGH RAFT, AND LIFT PIT DETAILS

PENETRATION TYPE LEGEND

MECHANICAL SHAFT / PENETRATION ELECTRICAL/COMMS SHAFT / PENETRATION HYDRAULIC SHAFT / PENETRATION

FIRE SHAFT / PENETRATION

DRAWINGS STATUS:
- LEVEL 04-09 ARE NOT FOR CONSTRUCTION AS THEY ARE NOT PART OF CC2

SERVICES STRUCTURAL PENETRATIONS BASED ON:

 \cdots

- MECHANICAL AND GAS SERVICES PENETRATIONS AS PER Fred Air-GCOR-000307, RCC-GCOR-003665, Fred Air-GCOR-000446, Fred Air-GCOR-000404



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Sydney
Local Health District

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Scale / North Point 1:50 @ A1 0 0.5 1 1.5 2.5M 1:100 @ A3

Drawing Status FOR CONSTRUCTION


EASTERN CORE SETOUT ELEVATIONS -SHEET 02

GG

Project Number Drawing Number D0353

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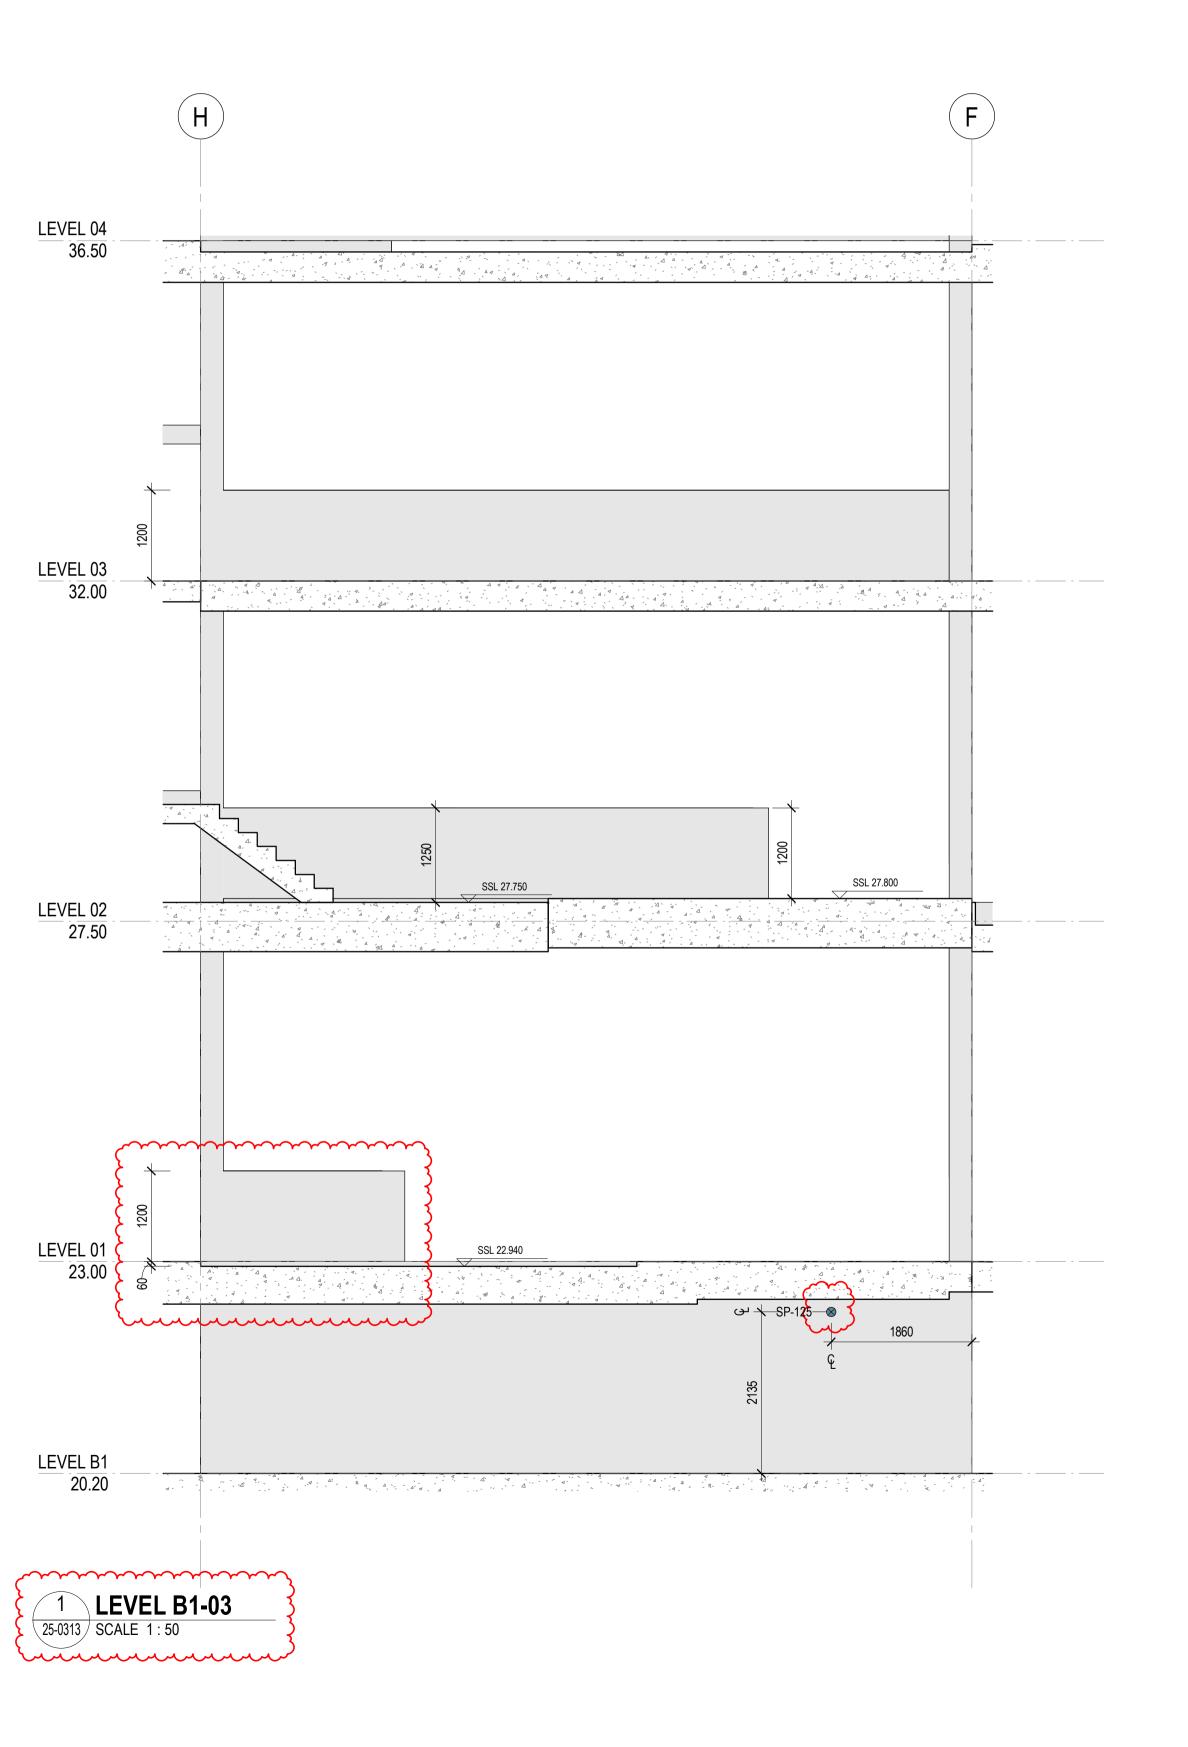
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No. 203

RBC00029

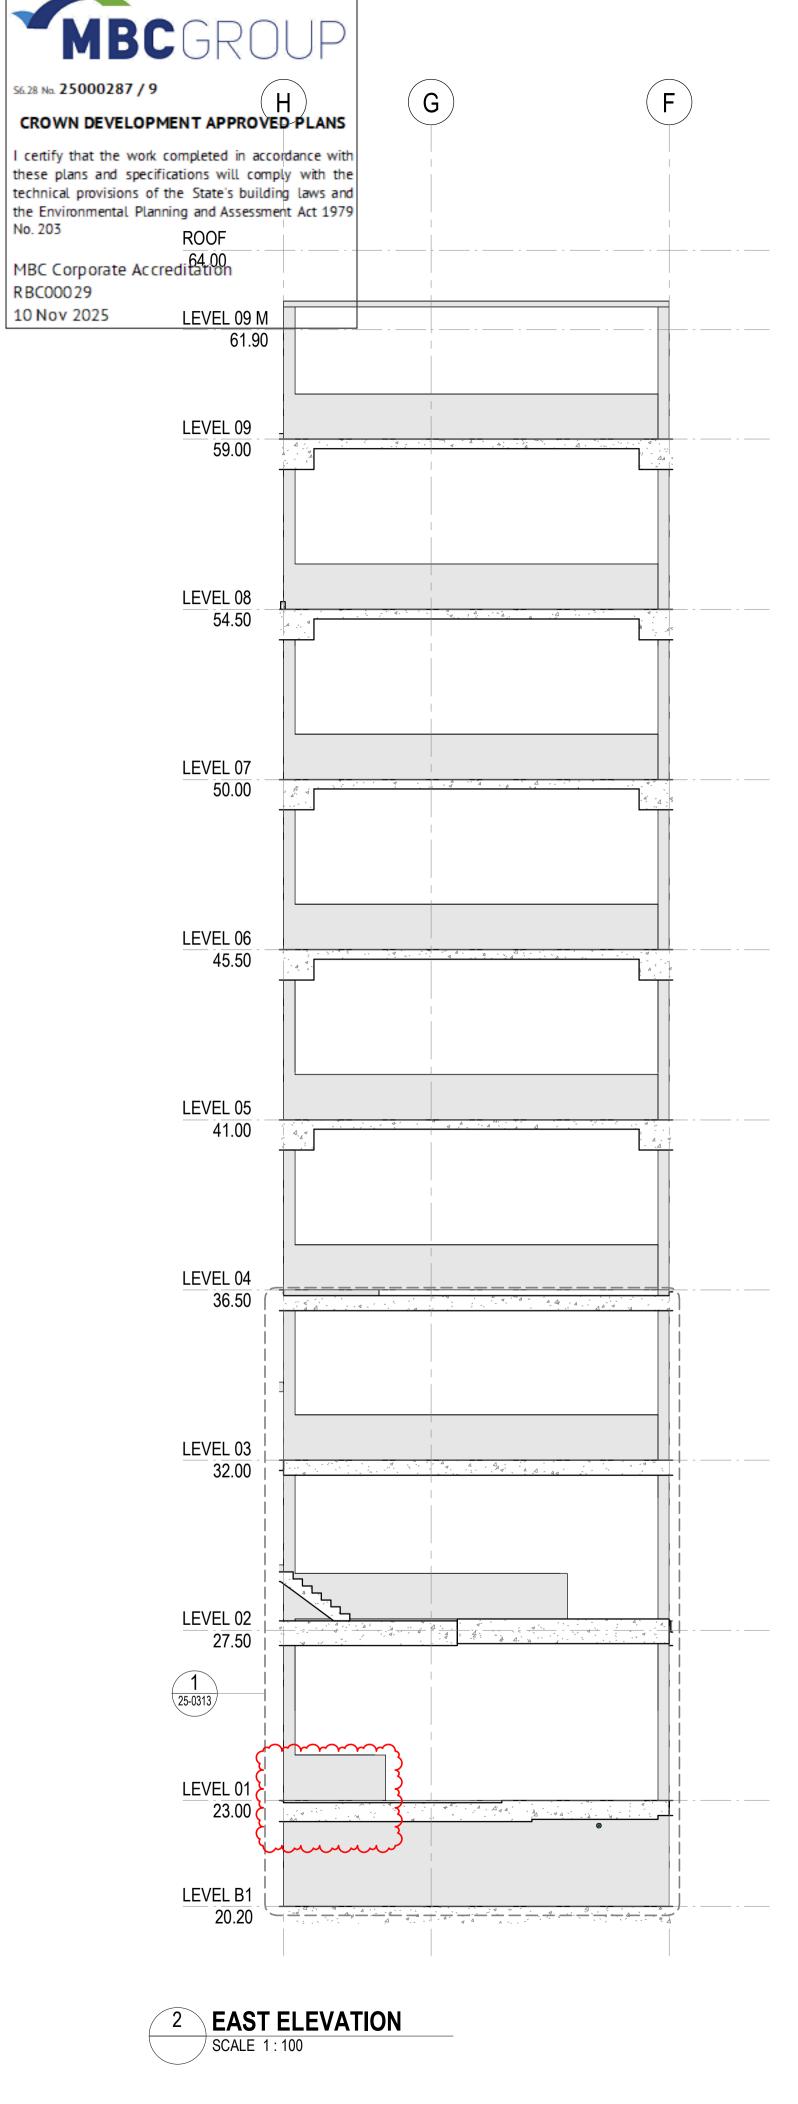10 Nov 2025



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No. Date App Revision or reason for issue B 06/10/2025 WP IFC - CC2 C 21/10/2025 BG IFC - CC2

GENERAL NOTES

1. REFER LEGENDS AND GENERAL NOTES ON DRAWING A20 0000; A20 0010; A20 0020; A20 0100 2. TO BE READ IN CONJUNCTION WITH STRUCTURAL ENGINEER'S DOCUMENTATION FOR STRUCTURES SIZE AND THICKNESS

3. PENETRATIONS SMALLER THAN 50MM DIA ARE OMITTED

LEGEND

FOUNDATION STRUCTURES. REFER TO A22 DRAWING SERIES FOR RAFT, PENETRATIONS THROUGH RAFT, AND LIFT PIT DETAILS

PENETRATION TYPE LEGEND

MECHANICAL SHAFT / PENETRATION ELECTRICAL/COMMS SHAFT / PENETRATION

HYDRAULIC SHAFT / PENETRATION FIRE SHAFT / PENETRATION

DRAWINGS STATUS:
- LEVEL 04-09 ARE NOT FOR CONSTRUCTION AS THEY ARE NOT PART OF CC2 SECURITY SERVICES PENETRATIONS NOT INCLUDED
- STRUCTURAL DOOR OPENINGS AS PER RCC-GCOR-003669



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Scale / North Point

Drawing Status FOR CONSTRUCTION


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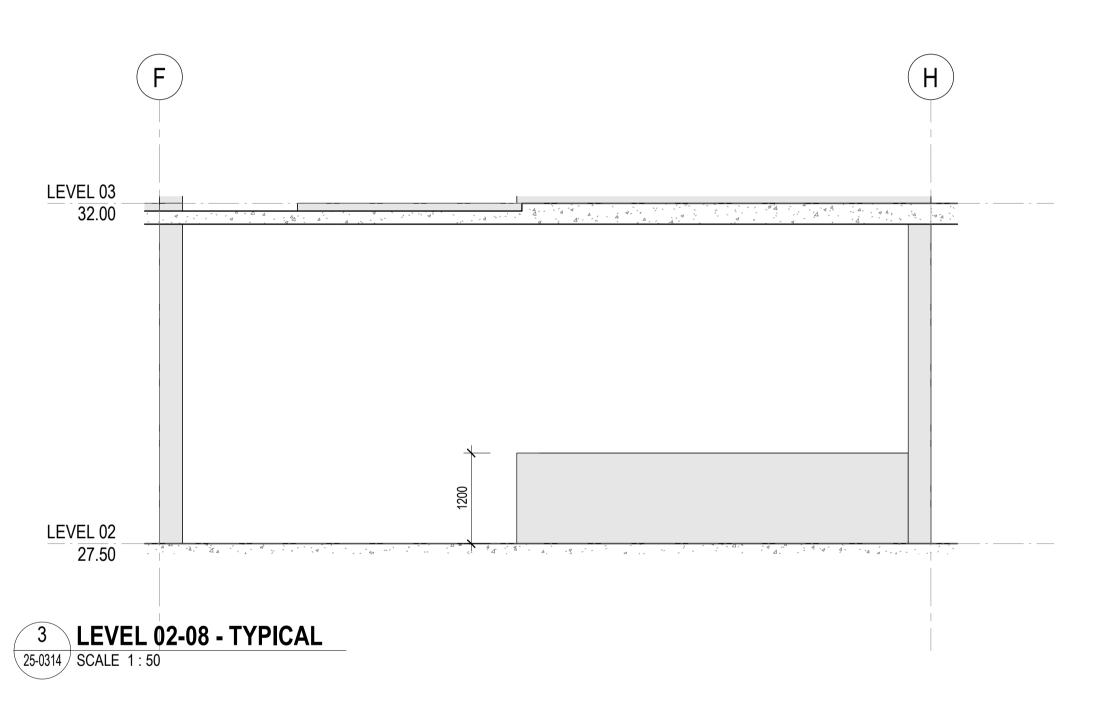
Project Number D0353


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Drawing Number D19-A-X-25-0313

21/10/2025 2:19:23 PM 21/10/2025





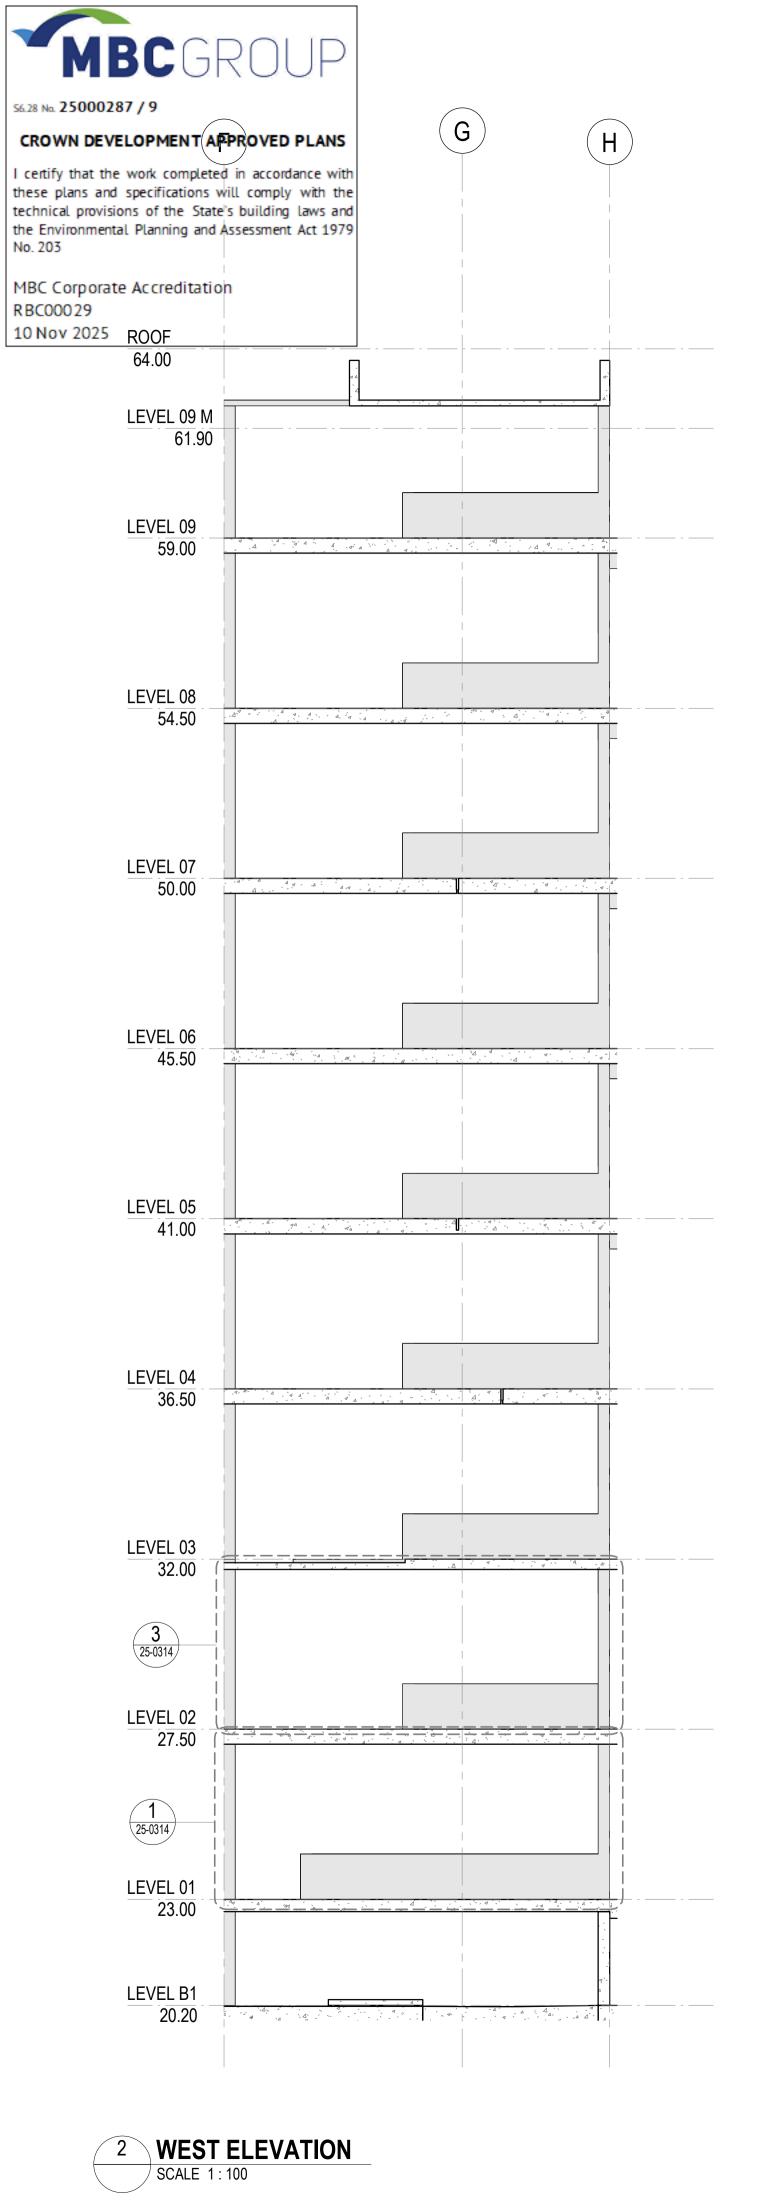
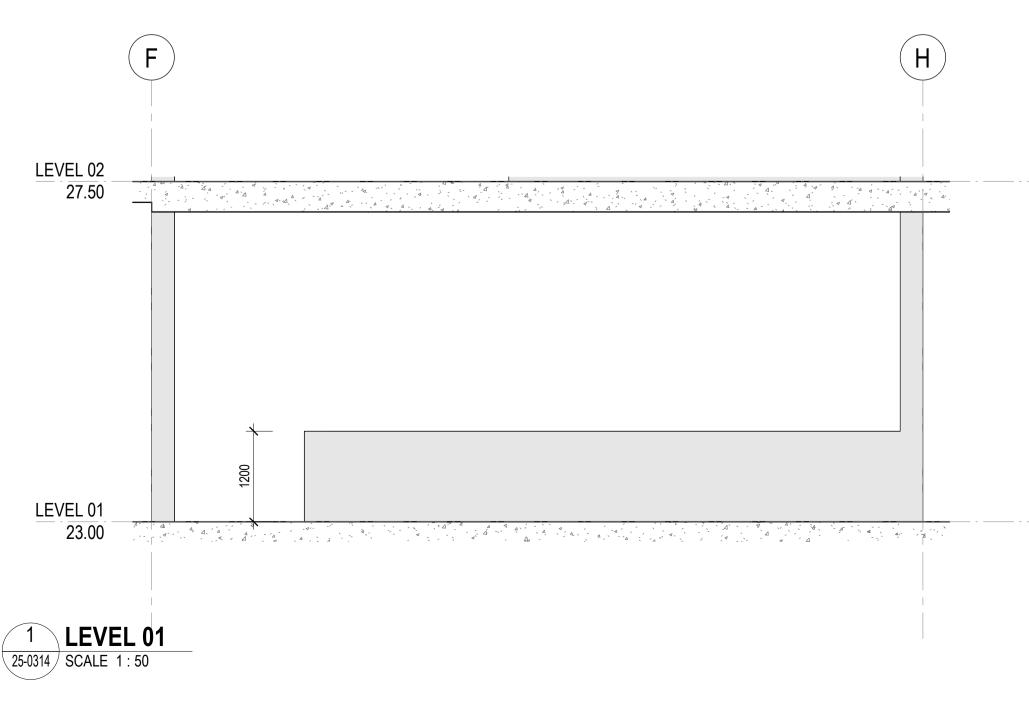
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GENERAL NOTES

1. REFER LEGENDS AND GENERAL NOTES ON DRAWING A20_0000; A20_0010; A20_0020; A20_0100 2. TO BE READ IN CONJUNCTION WITH STRUCTURAL ENGINEER'S DOCUMENTATION FOR STRUCTURES SIZE AND THICKNESS

3. PENETRATIONS SMALLER THAN 50MM DIA ARE OMITTED

LEGEND

FOUNDATION STRUCTURES. REFER TO A22 DRAWING SERIES FOR RAFT, PENETRATIONS THROUGH RAFT, AND LIFT PIT DETAILS

PENETRATION TYPE LEGEND

MECHANICAL SHAFT / PENETRATION ELECTRICAL/COMMS SHAFT / PENETRATION HYDRAULIC SHAFT / PENETRATION

FIRE SHAFT / PENETRATION

DRAWINGS STATUS:
- LEVEL 04-09 ARE NOT FOR CONSTRUCTION AS THEY ARE NOT PART OF CC2



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Scale / North Point 1:50 @ A1 0 0.5 1 1.5 2.5M 1:100 @ A3

Drawing Status FOR CONSTRUCTION

EASTERN CORE SETOUT ELEVATIONS -SHEET 04

GG Project Number

D0353

Drawing Number D19-A-X-25-0314 C

21/10/2025 2:19:27 PM 21/10/2025



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No. Date App Revision or reason for issue B 06/10/2025 WP IFC - CC2

1. REFER LEGENDS AND GENERAL NOTES ON DRAWING A20 0000; A20 0010; A20 0020; A20 0100 2. TO BE READ IN CONJUNCTION WITH STRUCTURAL ENGINEER'S DOCUMENTATION FOR STRUCTURES SIZE

3. PENETRATIONS SMALLER THAN 50MM DIA ARE OMITTED

FOUNDATION STRUCTURES. REFER TO A22 DRAWING SERIES FOR RAFT, PENETRATIONS

MECHANICAL SHAFT / PENETRATION ELECTRICAL/COMMS SHAFT / PENETRATION

HYDRAULIC SHAFT / PENETRATION FIRE SHAFT / PENETRATION

SERVICES STRUCTURAL PENETRATIONS BASED ON: - MECHANICAL AND GAS SERVICES PENETRATIONS AS PEF Fred Air-GCOR-000307, RCC-GCOR-003665, Fred Air-GCOR-000380, MMcD-GCOR-000402



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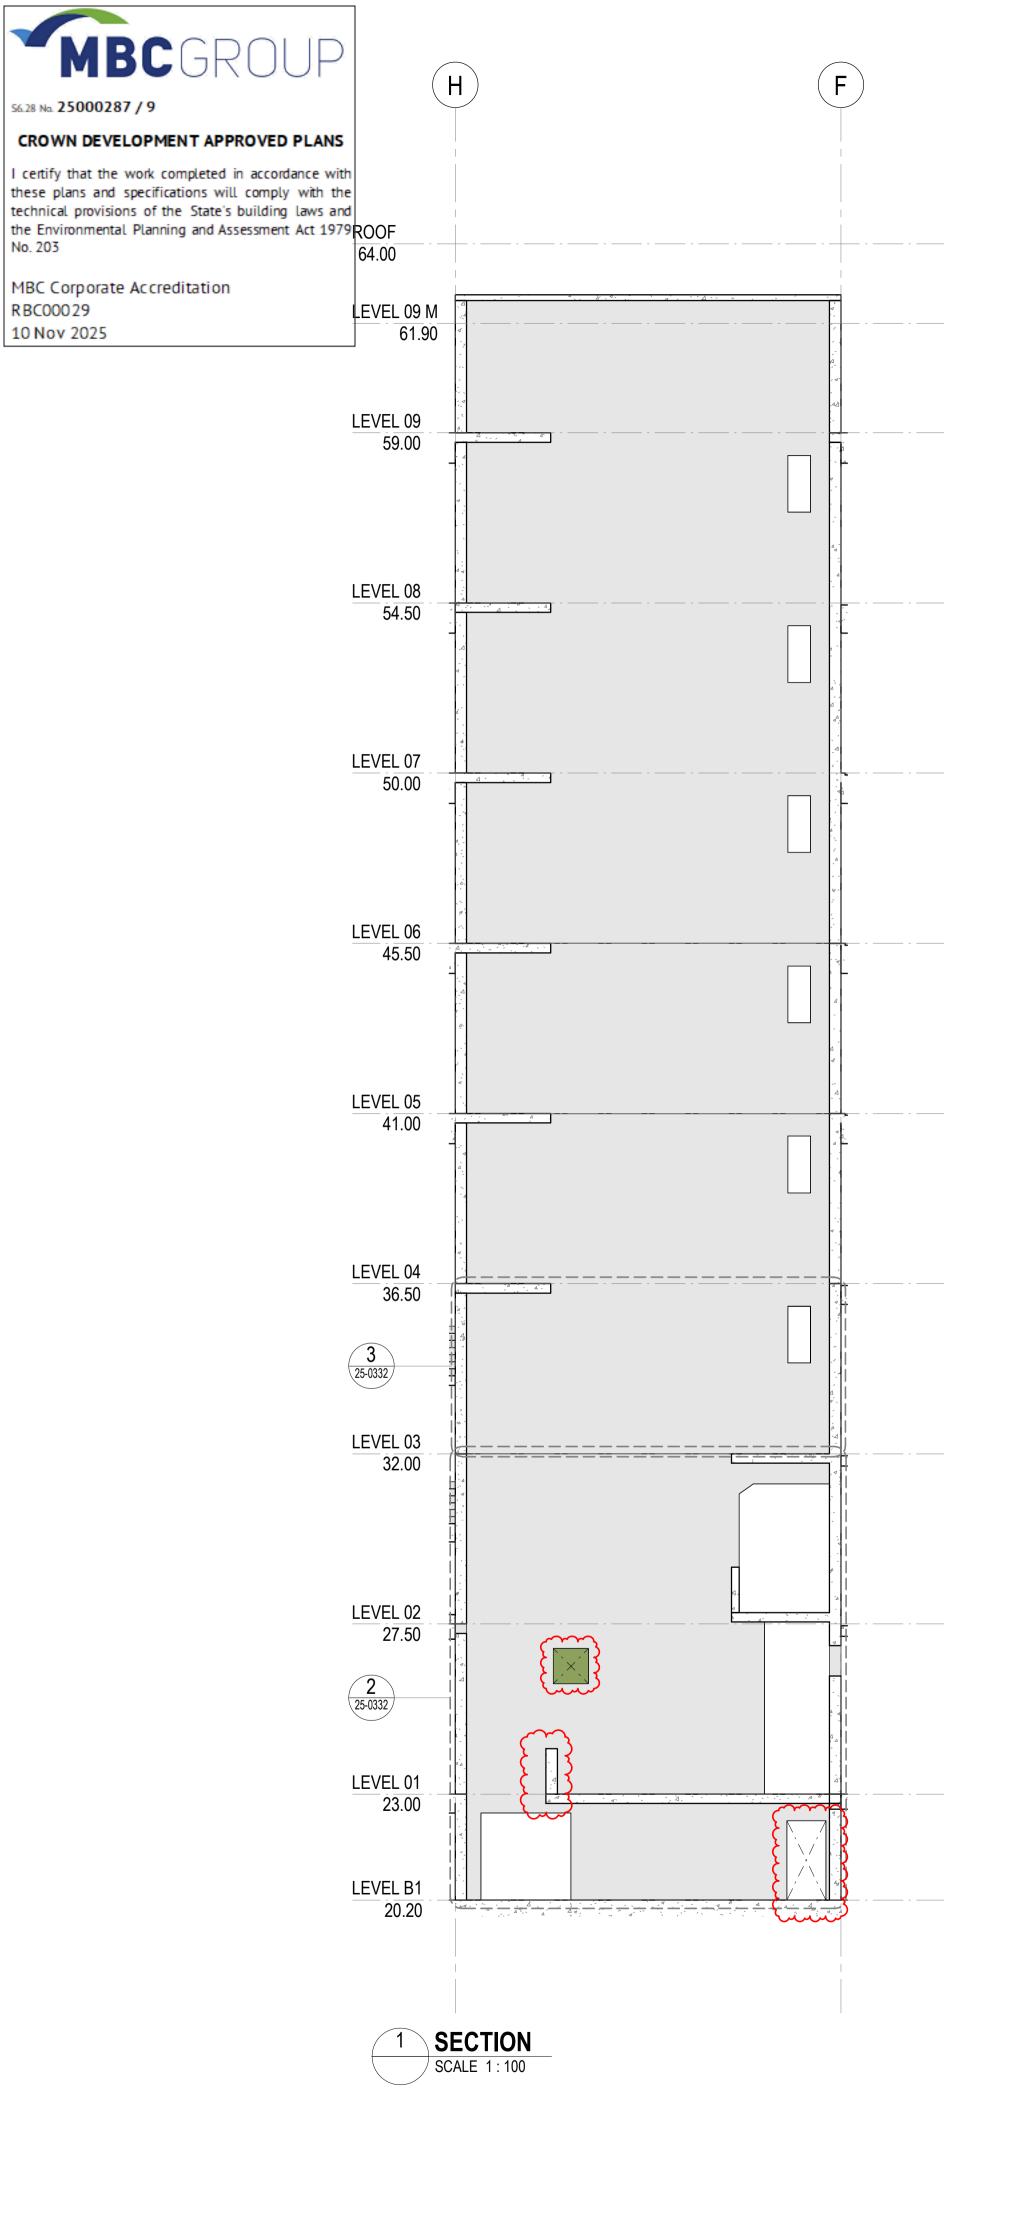
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Local Health District

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EASTERN CORE SETOUT SECTIONS

D19-A-X-25-0331 C





MBC Corporate Accreditation

No. 203

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10 Nov 2025



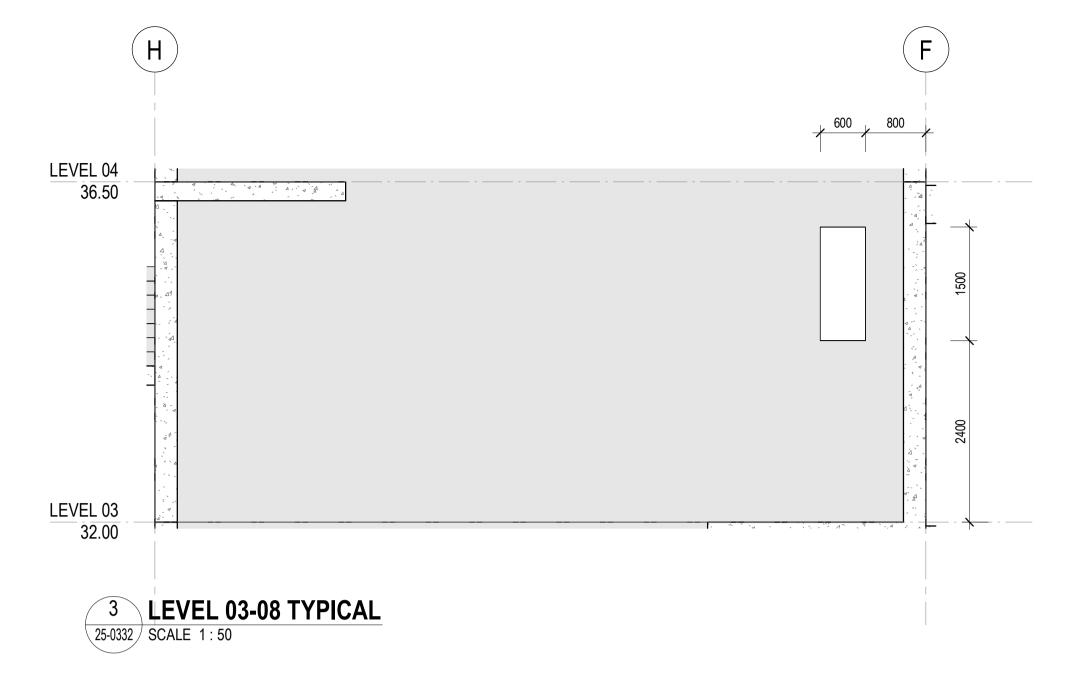
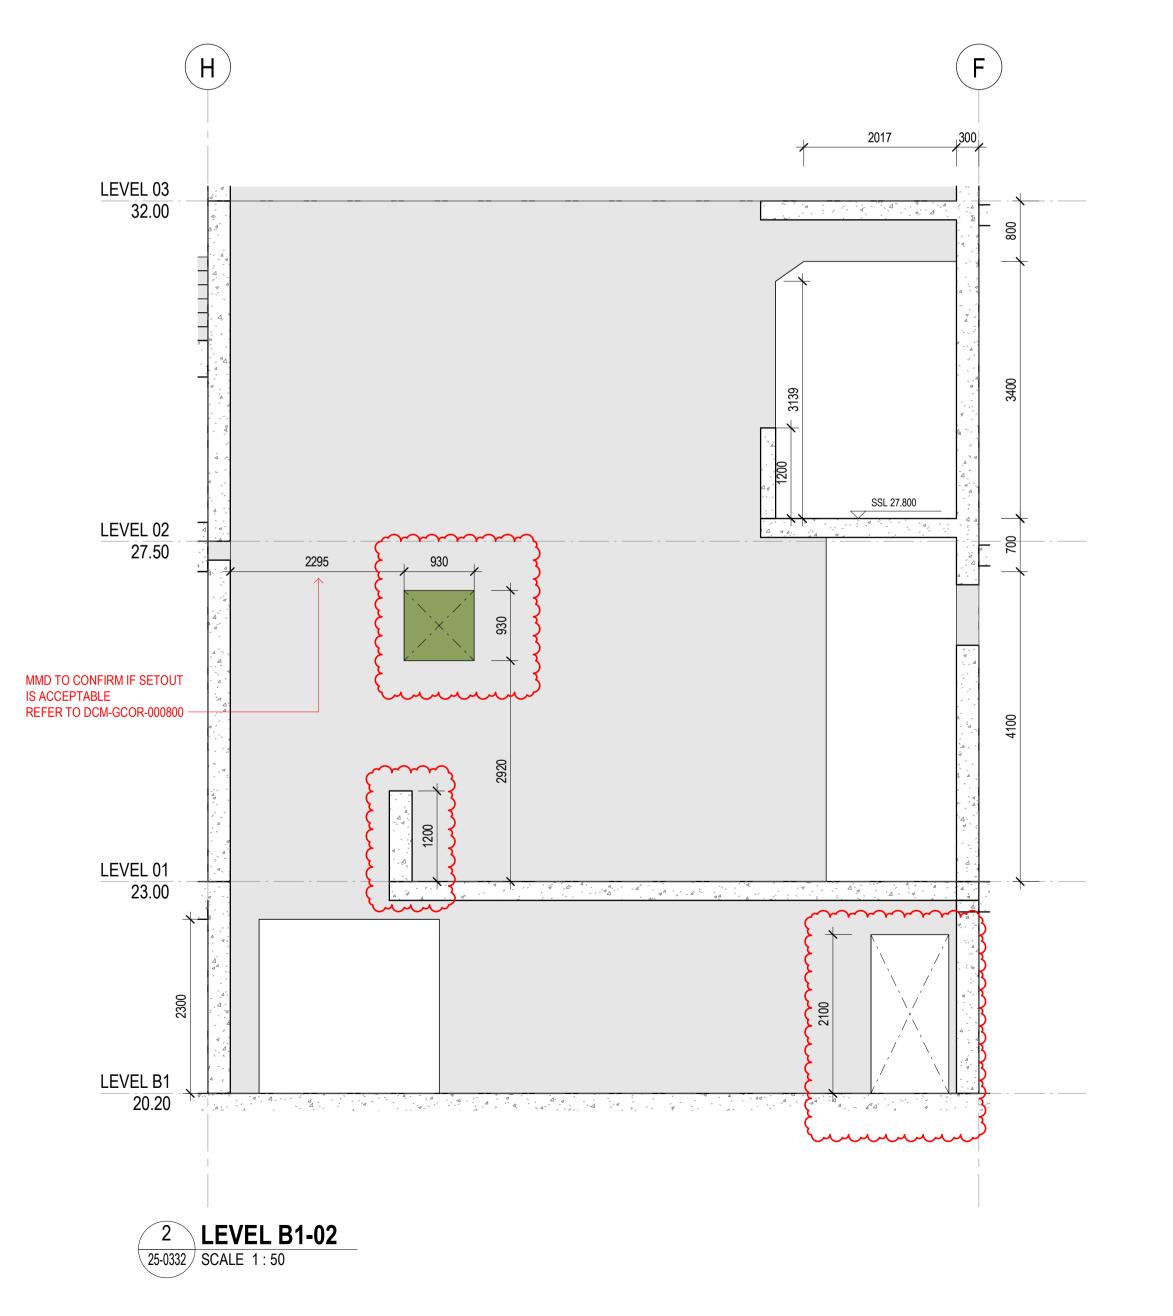
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GENERAL NOTES

1. REFER LEGENDS AND GENERAL NOTES ON DRAWING A20_0000; A20_0010; A20_0020; A20_0100 2. TO BE READ IN CONJUNCTION WITH STRUCTURAL ENGINEER'S DOCUMENTATION FOR STRUCTURES SIZE AND THICKNESS

3. PENETRATIONS SMALLER THAN 50MM DIA ARE OMITTED

LEGEND

FOUNDATION STRUCTURES. REFER TO A22 DRAWING SERIES FOR RAFT, PENETRATIONS THROUGH RAFT, AND LIFT PIT DETAILS

PENETRATION TYPE LEGEND

MECHANICAL SHAFT / PENETRATION ELECTRICAL/COMMS SHAFT / PENETRATION HYDRAULIC SHAFT / PENETRATION

FIRE SHAFT / PENETRATION

DRAWINGS STATUS:
- LEVEL 04-09 ARE NOT FOR CONSTRUCTION AS THEY ARE NOT PART OF CC2

- SECURITY SERVICES PENETRATIONS NOT INCLUDED - STRUCTURAL DOOR OPENINGS AS PER RCC-GCOR-003669

 \cdots SERVICES STRUCTURAL PENETRATIONS BASED ON: - MECHANICAL AND GAS SERVICES PENETRATIONS AS PER Fred Air-GCOR-000307, RCC-GCOR-003665, Fred Air-



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Drawing Status FOR CONSTRUCTION

Scale / North Point

EASTERN CORE SETOUT SECTIONS SHEET 02

GG


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21/10/2025 2:19:42 PM 21/10/2025

CROWN DEVELOPMENT APPROVED PLANS

I certify that the work completed in accordance with these plans and specifications will comply with the technical provisions of the State's building laws and the Environmental Planning and Assessment Act 1979 No. 203

MBC Corporate Accreditation RBC00029 10 Nov 2025

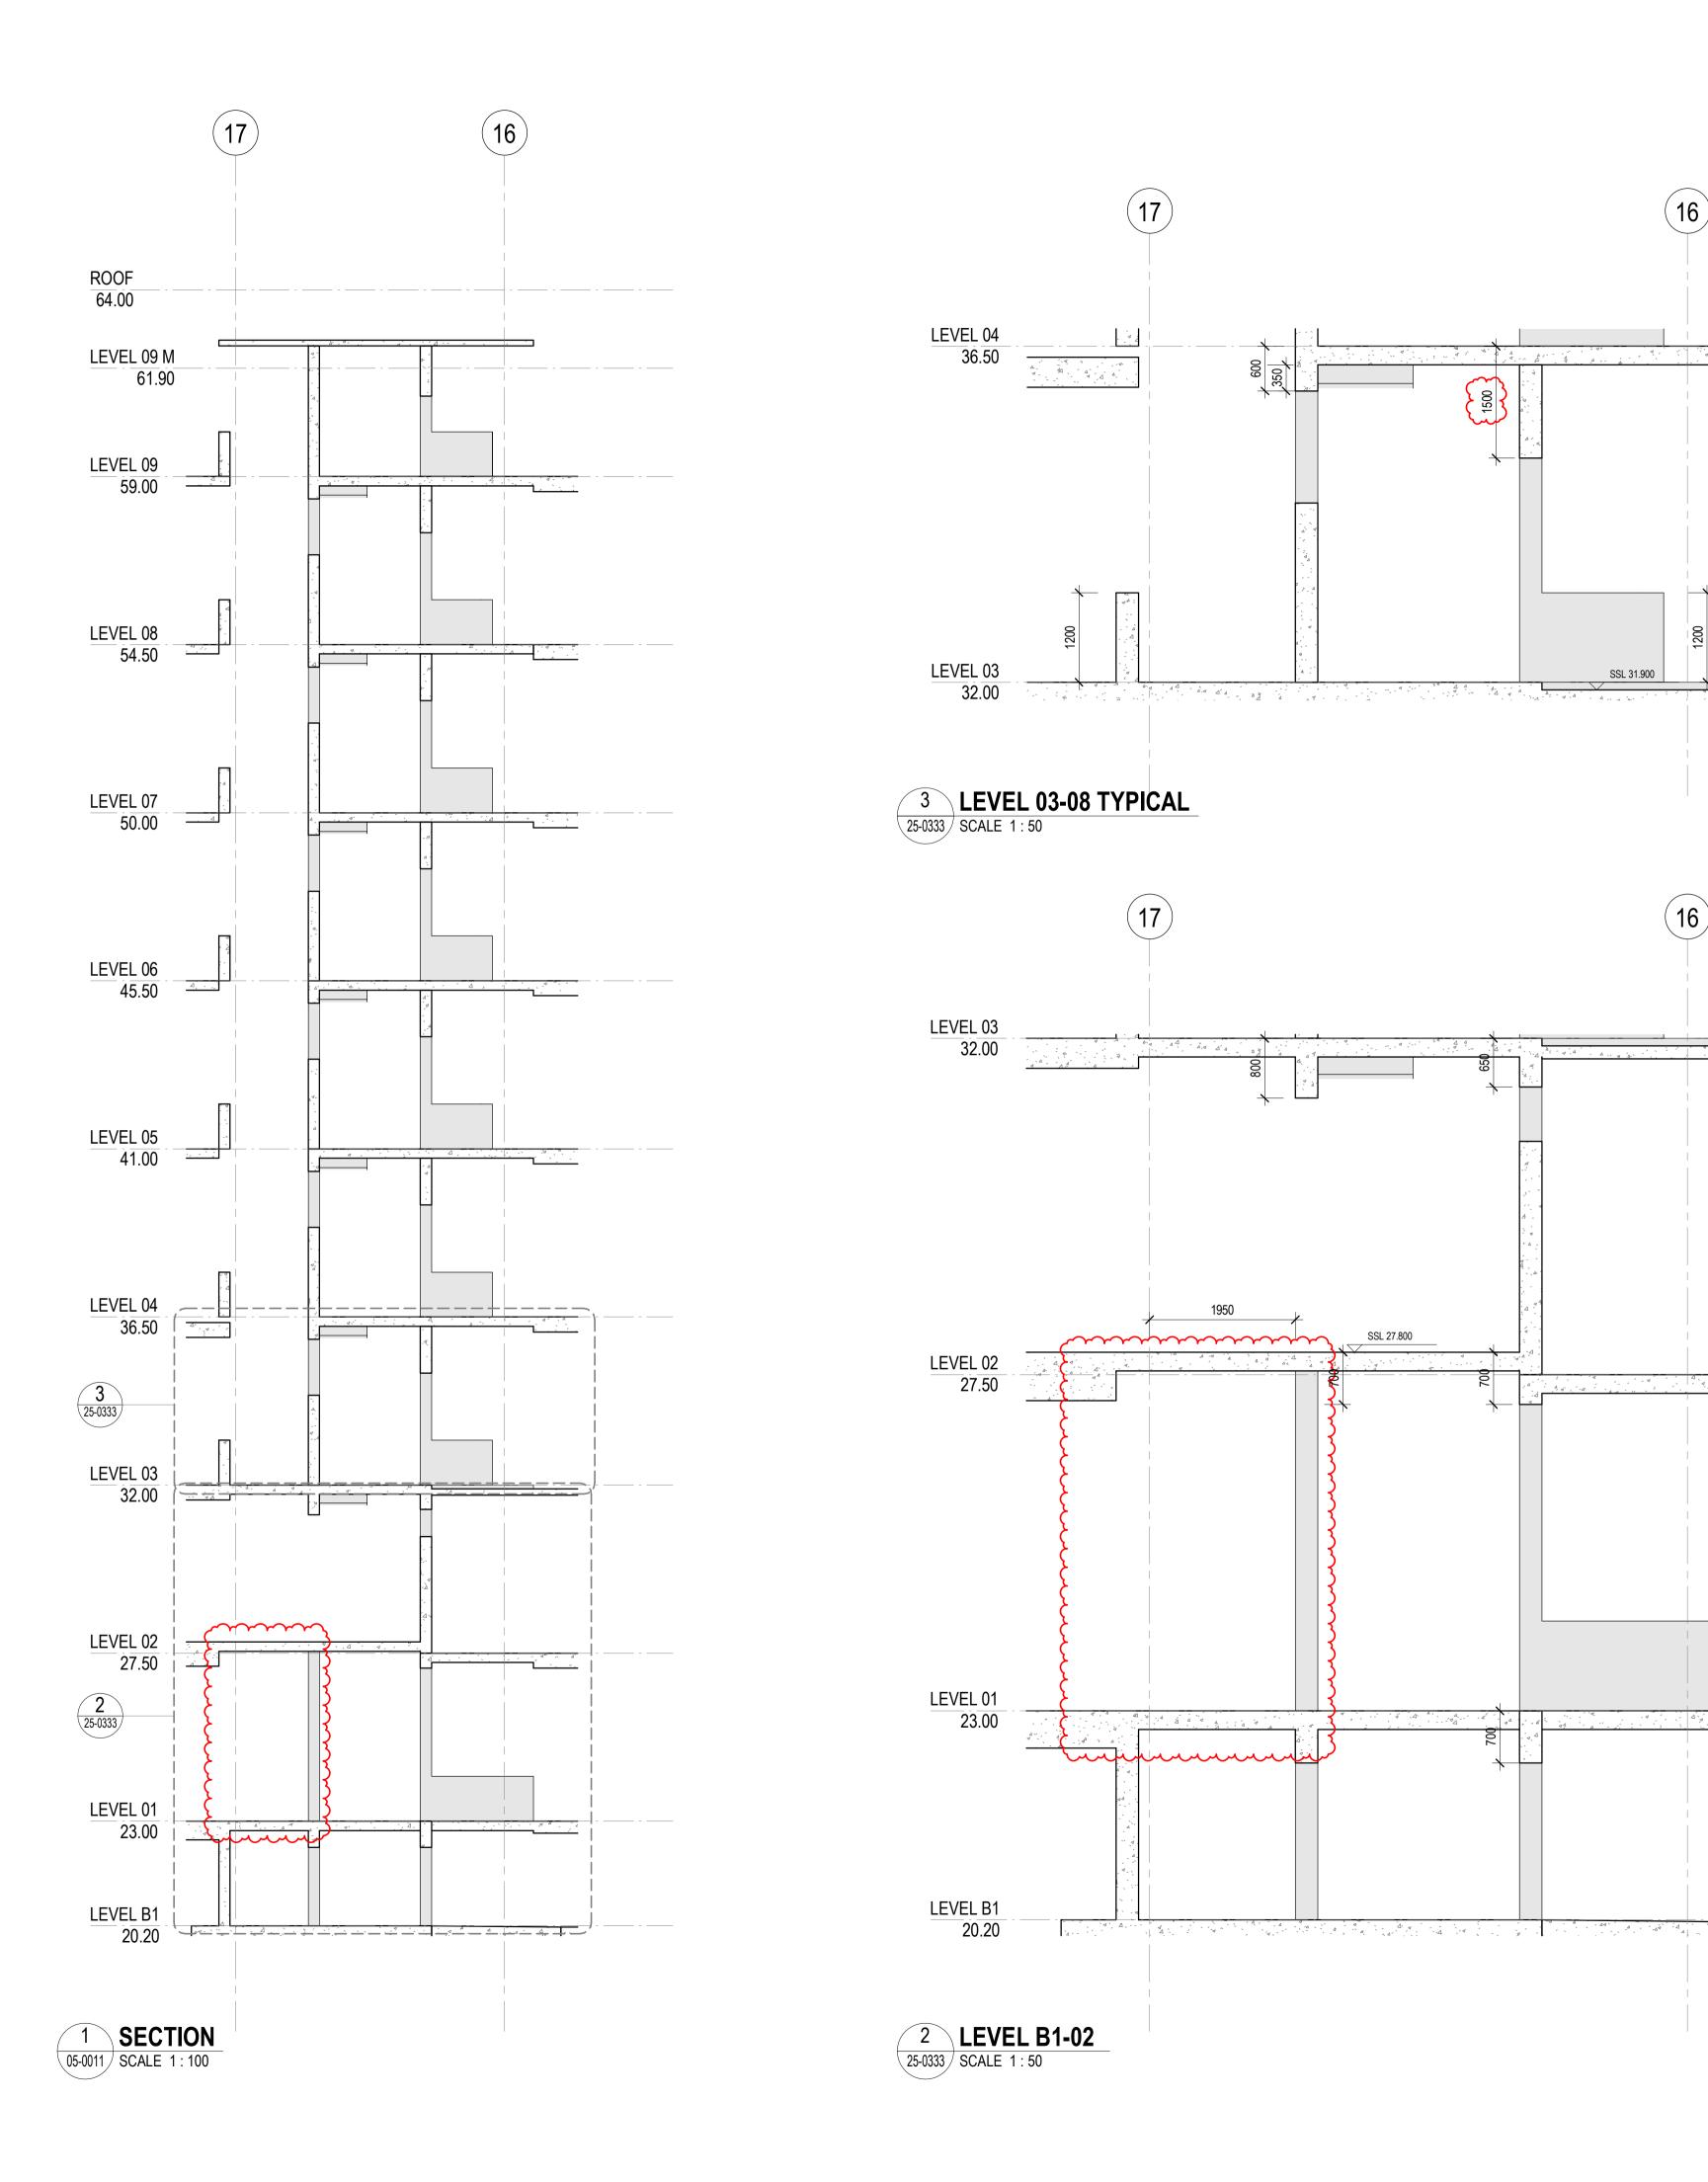

General Notes

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No. Date App Revision or reason for issue B 06/10/2025 WP IFC - CC2 C 21/10/2025 BG IFC - CC2

GENERAL NOTES

1. REFER LEGENDS AND GENERAL NOTES ON DRAWING A20_0000; A20_0010; A20_0020; A20_0100 2. TO BE READ IN CONJUNCTION WITH STRUCTURAL ENGINEER'S DOCUMENTATION FOR STRUCTURES SIZE AND THICKNESS

3. PENETRATIONS SMALLER THAN 50MM DIA ARE OMITTED

LEGEND

FOUNDATION STRUCTURES. REFER TO A22 DRAWING SERIES FOR RAFT, PENETRATIONS THROUGH RAFT, AND LIFT PIT DETAILS

PENETRATION TYPE LEGEND

MECHANICAL SHAFT / PENETRATION ELECTRICAL/COMMS SHAFT / PENETRATION HYDRAULIC SHAFT / PENETRATION

FIRE SHAFT / PENETRATION

DRAWINGS STATUS:
- LEVEL 04-09 ARE NOT FOR CONSTRUCTION AS THEY ARE NOT PART OF CC2 - SECURITY SERVICES PENETRATIONS NOT INCLUDED - STRUCTURAL DOOR OPENINGS AS PER RCC-GCOR-003669

SERVICES STRUCTURAL PENETRATIONS BASED ON: - STRUCTURES AS PER MMcD-GCOR-000421



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Scale / North	Point				
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Drawing Status FOR CONSTRUCTION

EASTERN CORE SETOUT SECTIONS SHEET 03

Project Number D0353

GG

Drawing Number D19-A-X-25-0333


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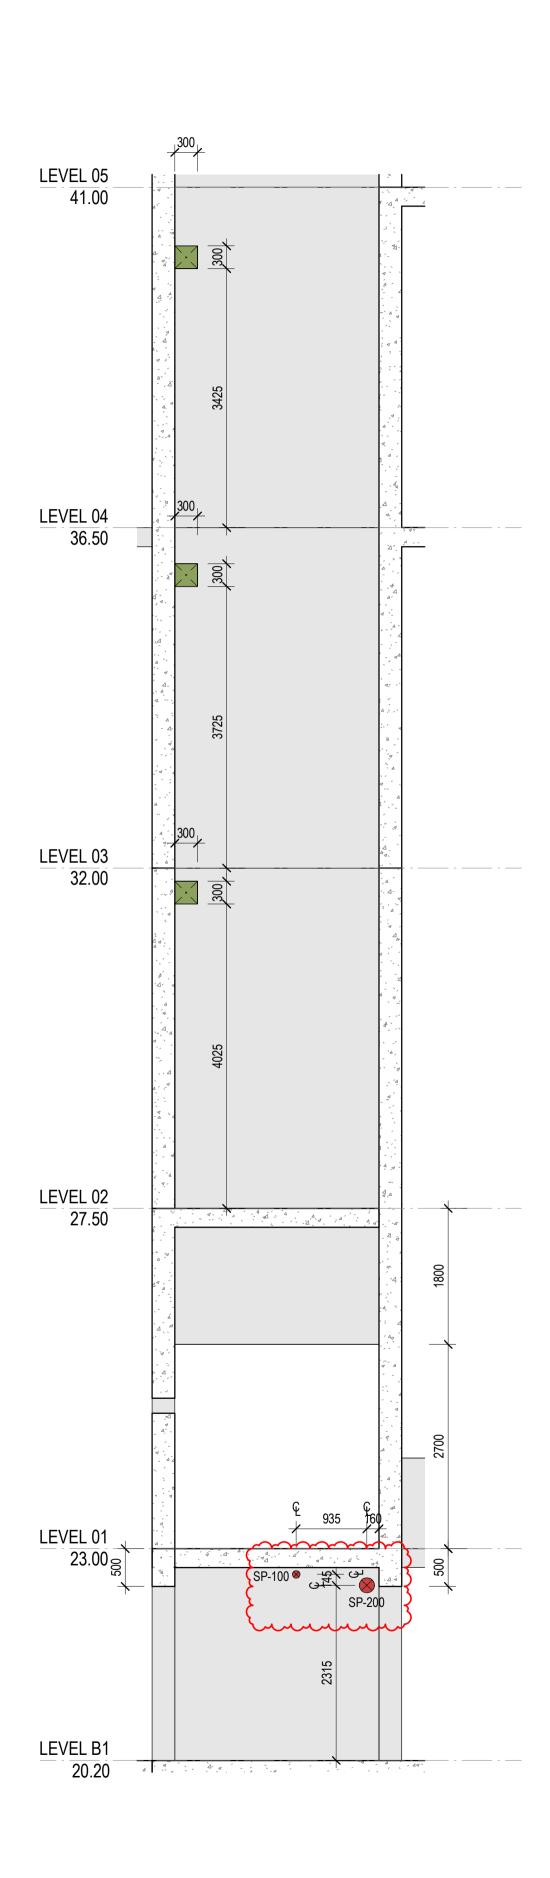
CROWN DEVELOPMENT APPROVED PLANS

I certify that the work completed in accordance with these plans and specifications will comply with the technical provisions of the State's building laws and the Environmental Planning and Assessment Act 1979 No. 203


MBC Corporate Accreditation RBC00029

10 Nov 2025



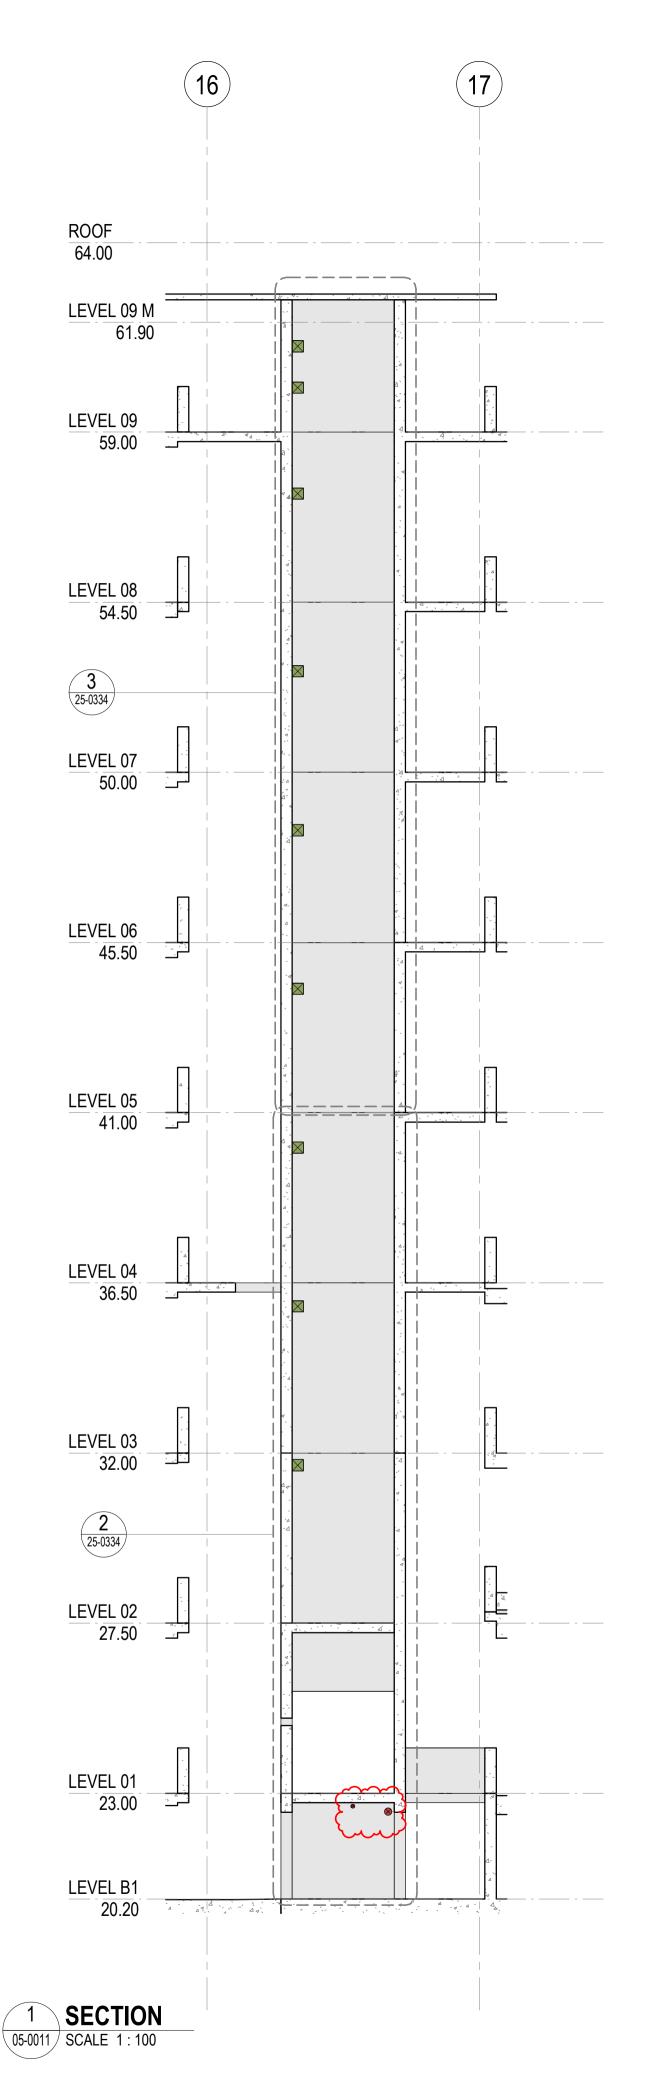



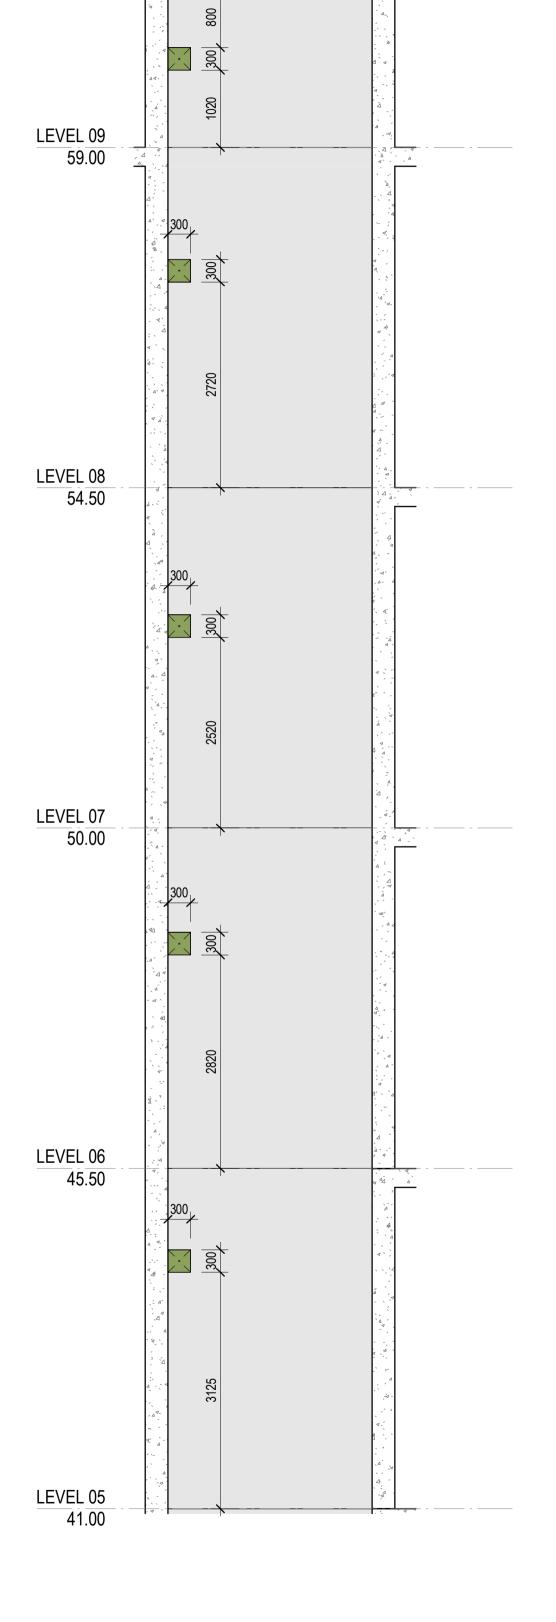

3 **LEVEL 05-08** 25-0334 SCALE 1:50

LEVEL 09 M

61.90

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No. Date App Revision or reason for issue B 06/10/2025 WP IFC - CC2 C 21/10/2025 BG IFC - CC2

GENERAL NOTES

1. REFER LEGENDS AND GENERAL NOTES ON DRAWING A20_0000; A20_0010; A20_0020; A20_0100 2. TO BE READ IN CONJUNCTION WITH STRUCTURAL ENGINEER'S DOCUMENTATION FOR STRUCTURES SIZE

AND THICKNESS 3. PENETRATIONS SMALLER THAN 50MM DIA ARE OMITTED

LEGEND

FOUNDATION STRUCTURES. REFER TO A22 DRAWING SERIES FOR RAFT, PENETRATIONS THROUGH RAFT, AND LIFT PIT DETAILS

PENETRATION TYPE LEGEND

MECHANICAL SHAFT / PENETRATION ELECTRICAL/COMMS SHAFT / PENETRATION HYDRAULIC SHAFT / PENETRATION

FIRE SHAFT / PENETRATION

DRAWINGS STATUS: - LEVEL 04-09 ARE NOT FOR CONSTRUCTION AS THEY ARE

NOT PART OF CC2 - SECURITY SERVICES PENETRATIONS NOT INCLUDED - STRUCTURAL DOOR OPENINGS AS PER RCC-GCOR-003669

SERVICES STRUCTURAL PENETRATIONS BASED ON:

- MECHANICAL AND GAS SERVICES PENETRATIONS AS PER Fred Air-GCOR-000307, RCC-GCOR-003665, Fred Air-GCOR-000380



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Health Sydney
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Drawing Status

FOR CONSTRUCTION **EASTERN CORE SETOUT SECTIONS**


SHEET 04 GG

CG

Project Number Drawing Number D0353

D19-A-X-25-0334 C

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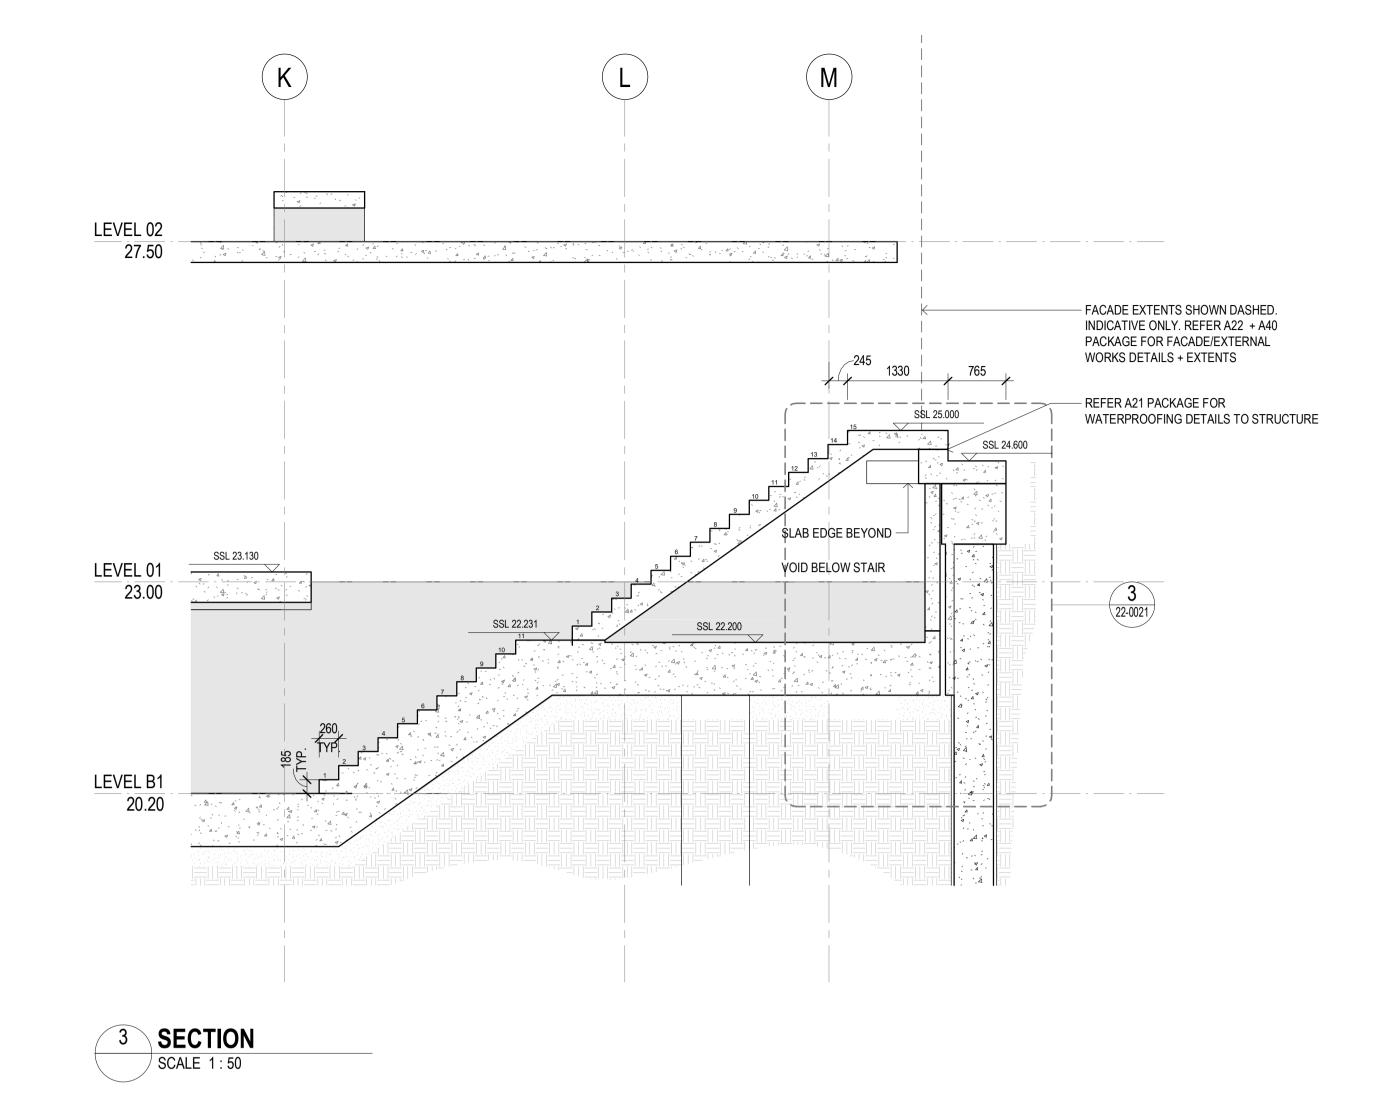


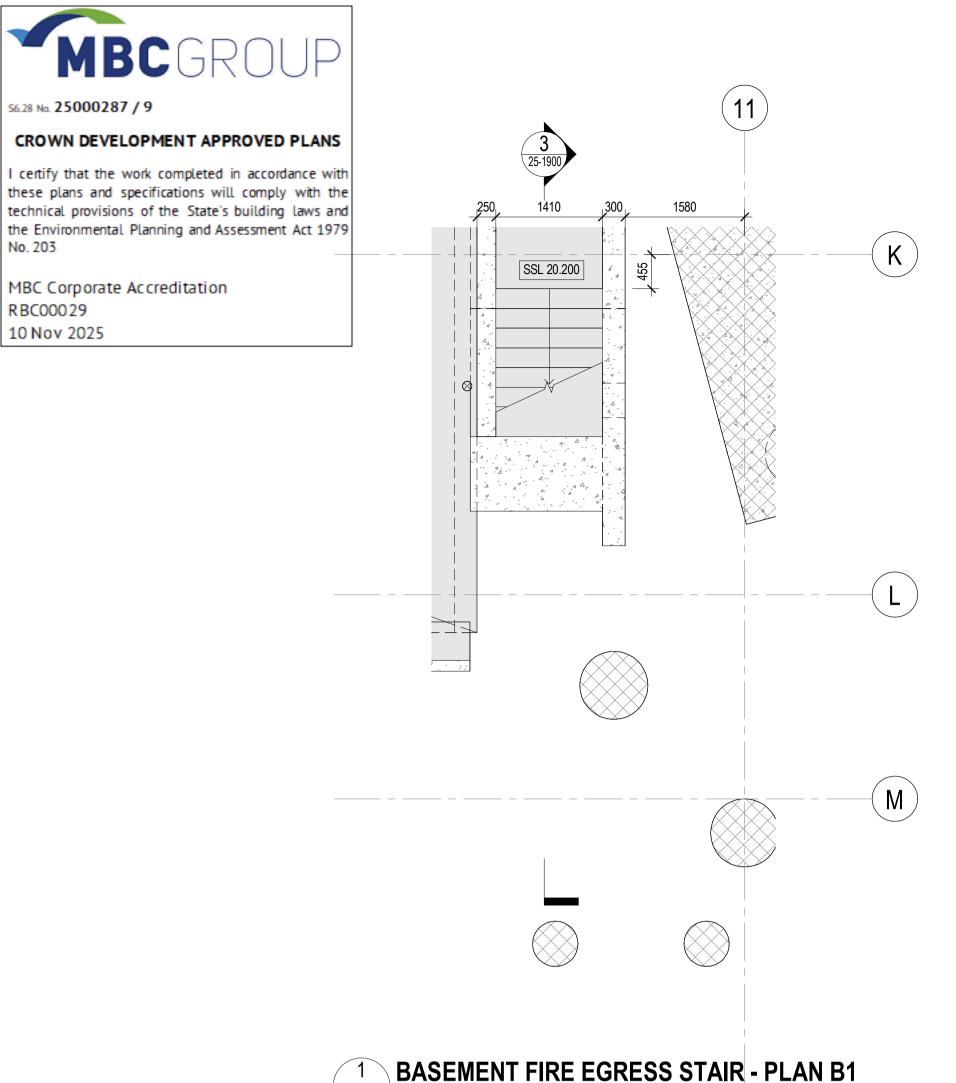
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No. 203

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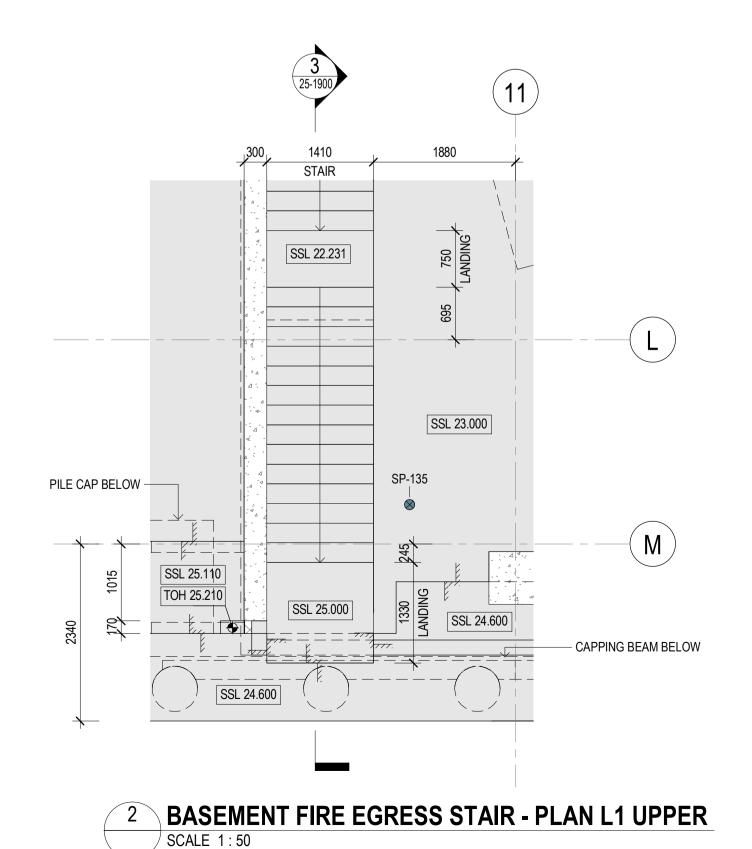
10 Nov 2025





SCALE 1:50

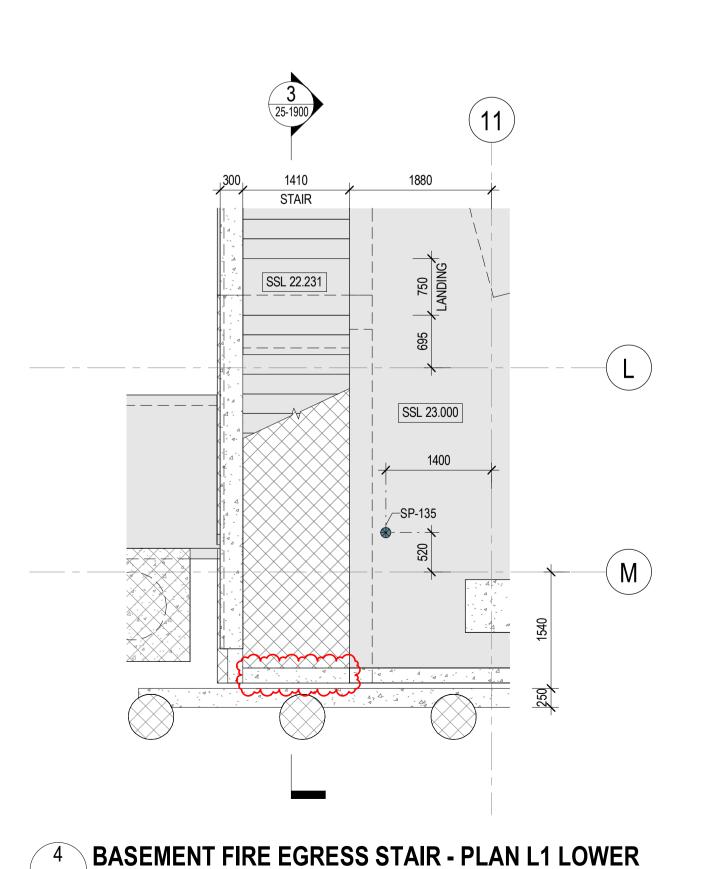SCALE 1:50



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OR ADJACENT TO STORMWATER ASSET & AS PER THE SPECIALIST ENGINEERING ASSESSMENT (SEA) PREPARED BY THE STRUCTURAL

PILES + FOUNDATION STRUCTURES ARE SHOWN FOR CONTEXT ONLY - REFER D19-A-00-20-0100 FOR RAFT SETOUT + PILING PLAN

CONTRACTOR TO ENSURE PILING SET OUTS ARE COMPLIANCE WITH THE SYDNEY WATER TECHNICAL GUIDELINES FOR BUILDING OVER

DIMENSIONS ARE TO CENTRE OF PILE & COLUMN AND PENETRATIONS U.N.O. ALL PILES ARE CENTRED TO SET-OUT GRIDS

COLUMN SETOUTS ARE NOT NECESSARILY CONCENTRIC THROUGH SUBSEQUENT FLOORS.

DRAWING STATUS: 1.INVERTED CLOUD AREAS ARE IN ABEYANCE AS PER NOTED

2. DISCIPLINES LISTED BELOW ARE COORDINATED REFLECTING THE MODELS SHARED TO DATE AND ACONEX CORRESPONDANCE THREAD RCC-GCOR-004344.

-STRUCTURE, LIFTS, MECHANICAL SERVICES, HYDRAULIC SERVICES FIRE SERVICES, ELECTRICAL SERVICES, GAS SERVICES



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Scale / North Point

Drawing Status FOR CONSTRUCTION

Project Number

D0353

FIRE STAIR 09 - SHEET 01

CG

Drawing Number Revision D19-A-X-25-1900

24/10/2025 5:10:07 PM 24/10/2025



FIRE SAFETY SCHEDULE FORM

Part 10 of the Environmental Planning and Assessment (Development Certification and Fire Safety) Regulation 2021

Please note:

- 1. A fire safety schedule must deal with the whole of the building not just part of the building.
- 2. Please complete all sections in full using CAPITAL LETTERS.

Section 1: Location of the building

<u> </u>	
Address (street number, street name, suburb and postcode)	
3 PARRAMATTA ROAD, CAMPERDOWN NSW 2050	

Lot No. (if known)	CP/CP/SP No. (if known)	Building name (if applicable)
LOT 1	DP 1171804	SYDNEY BIOMEDICAL ACCELERATOR

Section 2: Reissue of Fire Safety Schedule (Section 80A of the Regulation)

✓ Not applicable - Fire Safety Schedule is not being reissued.✓ Reissued Fire Safety Schedule (please state reason below)				
Reason for Reissue of Schedule				
Original Schedule lost or destroyed	☐ Correction of errors or omissions			

Section 3: Reference details (Section 78 of the Regulation)

Reference type	Reference number (if known)
CROWN CERTIFICATE	22000687

Section 4: Fire safety measures for the building - excluding critical fire safety measures (Section 79 of the Regulation

Current Existing

Item No	Fire safety measure (current/existing)	Minimum standard of performance
1.	NIL	

Proposed (new or modified including section 84(6) of the Regulation)

Item No	Fire safety measure (proposed)	Minimum standard of performance		
	ISAAC WAKIL BIOMEDICAL BUILDING (IWBB)			
		BCA 2022 Section C4D14, AS 1905.1-2015, AS1905.2-2005 & Manufacturer's specifications		
	Self-closing, automatic closing and latching mechanisms	BCA 2022 Section C4D5, C4D6, C4D7, C4D8, C34D9, C4D12, Spec 12		
3	Automatic fail-safe devices	BCA 2022 Section C4D7, D3D24, D3D26, D3D27, Spec 12, AS 2118.1-2017, AS 1670.1-2018		

4	Automatic fire detection and alarm system	BCA 2022 Section E2D3, E2D4, E2D13, NSW Variation E2D16, E2D21
		Spec 20 Section S20C2, S20C3, S20C4, S20C6, S20C7
5	Automatic fire suppression system	BCA 2022 Section E1D4, Spec 17, 2118.1-2017, AS 2118.4-2012, AS 2118.6-2012 (Combined System)
6	Emergency lift	BCA 2022 Section E3D5, AS 1735.1-2016 AS 1735.2-2001, AS1735.11-1986, AS1735.12 1999
7	Emergency lighting	BCA 2022 Section E4D2, E4D3 E4D4, AS 2293.1-2018
8	Exit and directional signage	BCA 2022 Section E4D5, NSW E4D6 & E4D8, Spec 25 AS 2293.1-2018
9	Emergency warning and intercommunication systems	BCA 2022 Section E4D9, G3D8, AS 1670.4-2018
10	Fire alarm monitoring system	BCA 2022 Spec 20 Section S20C8, AS 1670.3-2018
11	Fire control centres 1.	BCA 2022 Section E1D15, Spec 19
12	Fire & Smoke dampers	BCA 2022 Section E2D3, C3D6, C4D13, C4D15, Spec 11, Spec 19 AS/NZS 1668.1-2015, AS 1682.1-2015, AS 1682.2-2015, Manufacturer's specifications
13	Fire doors	BCA 2022 Section C3D13, C3D14, C4D5, C4D7, C4D9, C4D12, Spec 12, AS 1905.1-2015
14	Fire hose reel systems	BCA 2022 Section E1D3, AS 2441-2005
15	Fire hydrant systems	BCA 2022 Section E1D3, AS 2419.1-2021, AS 2118.6-2012 (Combined System)
16	Fire seals (protecting openings and service penetrations in fire resisting components of the building)	BCA 2022 Section C4D15, Spec 13, AS 4072.1-2005, AS 1530.4-2014, Manufacturer's specifications
17	Fire shutters	BCA 2022 Section C4D5, Spec 12, AS 1530.4-2014, AS 1905.2-2005 tested prototype
18	Lightweight construction	BCA 2022 Section C2D9, Spec6, Manufacturer's specifications
19	Mechanical air handling systems	BCA 2022 Section C4D3, E2.2, Spec. E1.8, Spec E2.2a, Spec G3.8, AS/NZS 1668.1-2015, AS 1668.2-2012
20	Openings in fire-isolated lift shafts	BCA 2022 Section C3.10, AS 1735.11-1986
21	Occupant warning system	BCA 2022 Section E2D3, Spec 20 Section S20C7
22	Path of travel for stairways,	AS 1670.1-2018 Part 15 (107-109) of the Environmental Planning and
	passageway and ramps	Assessment (Development Certification and Fire Safety) Regulation 2021
23	Portable fire extinguishers	BCA 2022 Section E1D14, AS 2444-2001
24	Stair and Zone pressurisation systems	BCA 2022 Section E2D4, AS 1668.1-2015
25	Required automatic exit doors	BCA 2022 Section D3D24, D3D26
26	Sliding Fire Doors	BCA 2022 Section C4D7, AS1905.1-2015

27	Smoke detectors and heat detectors	BCA Section E2D3, Spec 20 S Section S20C3 AS 1670.1-2015, AS3786-2014
28	Smoke exhaust system	BCA 2022 Section E2D3, Spec 21, AS/NZS 1668.1-2015
29	Smoke doors	BCA 2022 Section C3D6, C3D15, Spec 11
30	Smoke-proof walls	BCA 2022 NSW Section C3D6, Spec 11
31	Solid core doors	BCA 2022 Section C4D12, NSW C4D12(10)
32	Standby power systems	BCA 2022 Spec 31
33	Wall wetting sprinkler and drencher systems	BCA 2022 Section C4D5, Spec 31, AS 2118.2-2021
34	Warning and operational signs	BCA 2022 Section C4D7, D3D28, E3D4, Spec 31, Part 15 (Section 108) of the Environmental Planning and Assessment (Development Certification and Fire Safety) Regulation 2021
35	Fire Engineered Performance Solution Report XXXXX, prepared by XXXX dated XXXX	Fire Engineered Performance Solution Report XXXXX, prepared by XXXX dated XXXX
		BUILDING B
	Access panels, doors and hoppers to fire-resisting shafts	BCA 2022 Section C4D14, AS 1905.1-2015, AS1905.2-2005 & Manufacturer's specifications
37	Self-closing, automatic closing and latching mechanisms	BCA 2022 Section C4D5, C4D6, C4D7, C4D8, C34D9, C4D12, Spec 12
38	Automatic fail-safe devices	BCA 2022 Section C4D7, D3D24, D3D26, D3D27, Spec 12, AS 2118.1-2017, AS 1670.1-2018
39	Automatic fire detection and alarm system	BCA 2022 Section E2D3, E2D4, E2D5, E2D6, E2D7, E2D8, E2D9, E2D10, E2D11, E2D12, E2D13, E2D14, E2D15, E2D16, E2D17, E2D18, E2D19, E2D20, E2D21 Spec 20 Section S20C2, S20C3, S20C4, S20C5, S20C6, S20C7
40	Automatic fire suppression system	BCA 2022 Section E1D4, Spec 17, Spec 18 FPAA101D, FPAA101H AS 2118.1-2017, AS 2118.4-2012, AS 2118.6-2012 (Combined System)
41	Emergency lift	BCA 2022 Section E3D5, AS 1735.1-2016 AS 1735.2-2001, AS1735.11-1986, AS1735.12 1999
42	Emergency lighting	BCA 2022 Section E4D2, E4D3 E4D4, AS 2293.1-2018
43	Exit and directional signage	BCA 2022 Section E4D5, NSW E4D6 & E4D8, Spec 25 AS 2293.1-2018
	Emergency warning and intercommunication systems	BCA 2022 Section E4D9, G3D8, AS 1670.4-2018
45	Fire alarm monitoring system	BCA 2022 Spec 20 Section S20C8, AS 1670.3-2018
46	Fire control centres 1.	BCA 2022 Section E1D15, Spec 19
47	Fire & Smoke dampers	BCA 2022 Section E2D3, C3D6, C4D13, C4D15, Spec 11, Spec 19 AS/NZS 1668.1-2015, AS 1682.1-2015, AS 1682.2-2015, Manufacturer's specifications
48	Fire doors	BCA 2022 Section C3D13, C3D14, C4D5, C4D7, C4D9, C4D12, Spec 12, AS 1905.1-2015

49	Fire hose reel systems	BCA 2022 Section E1D3, AS 2441-2005
50	Fire hydrant systems	BCA 2022 Section E1D3, AS 2419.1-2021, AS 2118.6-2012 (Combined System)
51	Fire seals (protecting openings and service penetrations in fire resisting components of the building)	BCA 2022 Section C4D15, Spec 13, AS 4072.1-2005, AS 1530.4-2014, Manufacturer's specifications
52	Fire shutters	BCA 2022 Section C4D5, Spec 12, AS 1530.4-2014, AS 1905.2-2005 tested prototype
53	Lightweight construction	BCA 2022 Section C2D9, Spec6, Manufacturer's specifications
54	Mechanical air handling systems	BCA 2022 Section C4D3, E2.2, Spec. E1.8, Spec E2.2a, Spec G3.8, AS/NZS 1668.1-2015, AS 1668.2-2012
55	Openings in fire-isolated lift shafts	BCA 2022 Section C3.10, AS 1735.11-1986
56	Occupant warning system	BCA 2022 Section E2D3, Spec 20 Section S20C7 AS 1670.1-2018
57	Path of travel for stairways, passageway and ramps	Part 15 (107-109) of the Environmental Planning and Assessment (Development Certification and Fire Safety) Regulation 2021
58	Portable fire extinguishers	BCA 2022 Section E1D14, AS 2444-2001
59	Stair and Zone pressurisation systems	BCA 2022 Section E2D4, AS 1668.1-2015
60	Required automatic exit doors	BCA 2022 Section D3D24, D3D26
61	Sliding Fire Doors	BCA 2022 Section C4D7,AS1905.1-2015
62	Smoke detectors and heat detectors	BCA Section E2D3, Spec 20 S Section S20C3 AS 1670.1- 2015, AS3786-2014
63	Smoke exhaust system	BCA 2022 Section E2D3, Spec 21, AS/NZS 1668.1-2015
64	Smoke doors	BCA 2022 Section C3D6, C3D15, Spec 11
65	Smoke-proof walls	BCA 2022 NSW Section C3D6, Spec 11
66	Solid core doors	BCA 2022 Section C4D12, NSW C4D12(10)
67	Standby power systems	BCA 2022 Spec 31
68	Wall wetting sprinkler and drencher systems	BCA 2022 Section C4D5, Spec 31, AS 2118.2-2021
69	Warning and operational signs	BCA 2022 Section C4D7, D3D28, E3D4, Spec 31, Part 15 (Section 108) of the Environmental Planning and Assessment (Development Certification and Fire Safety) Regulation 2021
70	Fire Engineered Performance Solution Report XXXXX, prepared by XXXX dated XXXX	Fire Engineered Performance Solution Report XXXXX, prepared by XXXX dated XXXX

Details of Fire Safety Building Code of Australia (BCA) Performance Solution Report(s)

non-compliance	Ref No/Title of report/Author/Date	BCA performance requirements	BCA DtS Provision(s) and details of non-compliance
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NIL	

Section 5: Critical fire safety measures - where applicable to the building (Section 79 of the Regulation)

Note: A critical fire safety measures is one where the performance is verified at intervals of less than 12 months through the submission of a supplementary few safety statement.

Current (existing)

Item No	Fire safety measure (current)	Minimum standard of performance
1.	NIL	

Proposed (new or modified including section 84(6) of the Regulation)

Item No	Fire safety measure (proposed)	Minimum standard of performance	
1.	NIL		

Section 6: Details of approved exemptions from compliance with BCA standards for a relevant fire safety system (Section 74 of the Regulation)

Item No	Relevant fire safety measure	Description of exemptions
1.	NIL	

Section 7: Name of authority or registered certifier issuing this schedule

Name	Organisation (business, relevant authority or council)
CURTIS SCHUMANN	MBC GROUP

Business Address (street number, street name and postcode)	
SUITE 3/18 SYDNEY ROAD, MANLY NSW 2095	

Registration Number (where applicable)	Date of issue
BDC3249	10 NOVEMBER 2025

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Building Commission NSW



FIRE SAFETY SCHEDULE INSTRUCTIONS TO COMPLETE FORM

Part 10 of the Environmental Planning and Assessment (Development Certification and Fire Safety) Regulation 202

Information to help you complete the Fire Safety Schedule form

The following information is provided to help persons completing this fire safety schedule (FSS) template and does not comprise part of the form. The instructions do not have to be displayed in the building or submitted to the local Council or the Commissioner of Fire and Rescue NSW or attached to any fire safety certificate or annual fire safety statement.

General

- Please print in CAPITAL LETTERS and complete all relevant sections in full.
- A reference to 'the Regulation' is a reference to the *Environmental Planning and Assessment* (Development Certification and Fire Safety) Regulation 2021.
- The completed fire safety schedule form must be attached to the relevant application.
- An earlier fire safety schedule is superseded by a later fire safety schedule and ceases to have effect when the later fire safety schedule is issued.
- A fire safety schedule must deal with the whole of the building and not only the part of the building to
 which the development consent, complying development certificate, construction certificate or fire
 safety order relates.
- Further information about building fire safety is available on the 'Fire safety' page of the Department's website at https://www.fairtrading.nsw.gov.au/housing-and-property/reforms-to-fire-safety-regulation

Section 1: Description of the building

The address and other property details should be provided here.

Section 2: Reissue of Fire Safety Schedule

- The purpose of this section is to specify whether the fire safety schedule is a new schedule or a schedule that has been reissued under section 80A of the Regulation. Note: The building regulator (Building Commission NSW) does not reissue certificates under section 80A.
- An initial fire safety schedule issued when a Development Consent, Complying Development Certificate, Construction Certificate, or a fire safety order is issued is not taken to be a reissued Schedule.
- The reissue of a fire safety schedule may occur because the original schedule was lost or destroyed or to correct errors or omissions in the fire safety schedule.
- It must be noted that a fire safety schedule **cannot** be reissued under section 80A of the Regulation if the error or omission is due to building work or a change in plans or specifications for the fire safety measures of the building.
- A private certifier cannot reissue a schedule under s80A after an occupation certificate has been issued by the certifier.

A council that reissues a fire safety schedule where the 'original' was not required to be in the
approved form does not need to issue the replacement schedule on the approved form. Instead, a
council may reissue the schedule in the same form as the schedule being replaced.

Section 3: Reference details

- Provide details of the relevant reference document by selecting the relevant type from the dropdown list.
- Provide the reference number of the relevant Development Consent, Construction Certificate, Complying Development Certificate, Fire Safety Order Reference.
- Where the schedule is being issued for a Building Work Rectification Order under the *Residential Apartment Buildings (Compliance and Enforcement Powers) Act 2020* under section 33, the reference must include the date of the order and the name of the developer.
- Where the schedule is being issued in relation to an undertaking under Design and Building
 Practitioners Act 2020, section 88 or an undertaking under the Residential Apartment Buildings
 (Compliance and Enforcement Powers) Act 2020, section 28. The reference must include the date
 the undertaking was accepted by the Secretary and the name of the developer.
- For ease of use, only one reference to a relevant document type is necessary for filling out this part. It is unnecessary to reference multiple Development Consents, staged CCs, or CDCs that are or were once applicable to the building over its lifetime.

Section 4: Fire safety measures currently implemented OR proposed to be implemented for the building

The purpose of this section is to identify the current and proposed fire safety measures that must be implemented for the building.

Fire safety measures

- A proposed fire safety measure is taken to be either a required measure not currently installed in the building, or an existing measure which is being altered.
- Fire safety measures include both statutory fire safety measures and other fire safety measures.
 The statutory fire measures are specified in section 79(4) of the Regulation and include portable fire extinguishers, fire hydrants, fire sprinklers, fire detection and alarm systems, and lightweight construction.
- Other fire safety measures could include any measure that is specific to the building such as those required as part of a fire safety Building Code of Australia (BCA) performance solution for the building.

Minimum standard of performance

- The minimum standard of performance for a fire safety measure describes the technical specification for the design, installation and operation of the measures. The minimum standard of performance is generally determined by the BCA and should not be confused with the specified maintenance activities which are used for maintenance of a fire safety measure.
- When noting the minimum standard of performance for a fire safety measure (FSM) care needs to be taken to ensure relevant details are provided. When expressing a minimum standard of performance for an FSM, the following referencing sequence should be used:
 - 1. The Building Code of Australia (BCA) edition applicable to the FSM.
 - 2. Any relevant BCA Deemed-to-Satisfy Clause(s) or Specification(s).
 - 3. Any relevant Reference Document(s) (such as Australian Standards) and the applicable edition (year) of that Referenced Standard.
- If an application relates only to a part of a building and the required fire safety measures and their associated minimum standard of performance varies from other parts of the building, the fire safety

schedule must clearly identify the different fire safety measures and/or different standards of performance in a building.

Using the table

- If there are no existing fire safety measures, specify 'Nil' in the first row under both 'Current' and 'Minimum standard of performance'. The remaining rows of the table under 'Current' can be deleted.
- If there are no proposed fire safety measures specify 'Nil' in the first row under both 'Proposed' and 'Minimum standard of performance'. The remaining rows of the table under 'Proposed' can be deleted.
- Additional rows can be added under 'Current' and 'Proposed' measures if required.

Performance solutions

- The fire safety schedule must identify all fire safety measures that are required as part of a fire safety BCA performance solution, including any reference to the BCA performance solution report document when specifying the standard of performance for each measure.
- Provide identifying details of any fire engineered BCA performance solution report(s) relevant to those corresponding fire safety measures in the table 'Details of Building Code of Australia Performance Solution Report(s)'.
- Provide details of the report including the author of the report, the relevant BCA performance requirements about which the report demonstrates compliance, and a brief description of the relevant BCA deemed-to-satisfy provision(s) considered.

Section 5: Critical fire safety measures currently implemented OR proposed to be implemented in the building

- The purpose of this section is to identify those current or proposed critical fire safety measures for the building.
- A critical fire safety measure is a measure that requires periodic assessment and certification at intervals of less than 12 months, because of its nature, the environment, or other circumstances.
- Not all buildings will be subject to critical fire safety measures and this section must only be filled out
 when a building has critical fire safety measures as identified by the registered certifier (council or
 private) or appropriate authority.
- Each critical fire safety measure and the associated minimum standard of performance must be listed.
- Specify the intervals (of less than 12 months) at which the critical fire safety measure must be assessed and requires a supplementary fire safety statement to be submitted.
- It is up to the registered certifier (council or private) or appropriate authority to identify what is a critical fire safety measure and the frequency at which a supplementary fire safety statement is required to be lodged with the council.
- If there are no applicable critical fire safety measures insert 'Nil' in the row under 'Current', 'Proposed' and 'Minimum standard of performance'. The remaining rows of the table under 'Current' and 'Proposed' can be deleted.
- Additional rows can be added to the table if required.

Section 6: Exemption from BCA standard for a relevant fire safety system

- The purpose of this section is to identify in accordance with section 23(3)(b) of the Regulation any exemptions from BCA standards for the fire safety building work granted under a construction certificate by a certifier resulting from an objection under section 74 of the Regulation.
- Objections made under this provision relate to the operational performance of a relevant fire safety system.

- A relevant fire safety system is defined by the Regulation and can be either a hydraulic fire system, a fire detection and alarm system, or a mechanical ducted smoke control system.
- In this section the applicant must specify the relevant fire safety measure to which an exemption applies. A detailed description of the exemption must be provided.
- If there are no exemptions relevant to the building insert 'Nil' in the first row under both 'Relevant Fire Safety System' and 'Details of the exemption'. The remaining rows of the table can be deleted.
- Additional rows may be added to the table if required.

Section 7: Name and contact details of the person issuing the schedule

- The purpose of this section of the form is to include details of the person or authority that is issuing the schedule.
- Where the fire safety schedule is issued by a registered certifier, details of the registration number of the certifier are to be provided.
- The date of issue must also be included on the fire safety schedule.